# Premier ICF Installation Instructions


- 1.) Study all details thoroughly prior to starting Premier ICF installation.
- 2.) Footings shall be level, square, and of sufficient width to support the Premier ICF System.
- 3.) Layout concrete wall dimensions on footings with chalk lines.
- 4.) Install outside toe plate (see PICF-001 for no toe plate installation method), vertical outside corner, T-intersection and opening braces. Plumb and secure all bracing. (PICF-002, PICF-004, PICF-005) The contractor is responsible for providing adequate bracing of the Premier ICF system.
- 5.) Install first course of Premier ICF. Level as required. (PICF-001, PICF-002, PICF-009)
- 6.) Install inside toe plate (PICF-002 or for no toe plate installation method see PICF-001).
- 7.) Install all courses of Premier ICF wall starting from corners. Cut planks to fit wall.
- 8.) Place rebar vertically and horizontally as required. Use Premier ICF Tie<sub>®</sub> rebar cradles for positioning of the horizontal reinforcing. Do not drag rebar over ties.
- 9.) Maximum unsupported distance horizontally or vertically is 7".
- 10.) For openings (i.e., windows, doors, etc.) and wall terminations, consult Premier ICF details.
- 11.) Install walkway and vertical braces (PICF-002, PICF-002a) or other approved methods to support workers. This walkway may be used to plumb the wall.
- 12.) Concrete should be 5" slump, 3,000-4,000 psi strength, and maximum 34" aggregate size.
- 13.) Plywood and bracing materials should be available at the job site for remediation of unforeseen circumstances that may occur during the concrete pouring operations.
- 14.) Service temperature of Premier ICF Tie<sub>®</sub> is  $20^{\circ}F$  ( $-7^{\circ}C$ ) or warmer.

Updated 12-12-21

## PREMEIR ICF

TITLE:

Installation Recommendations

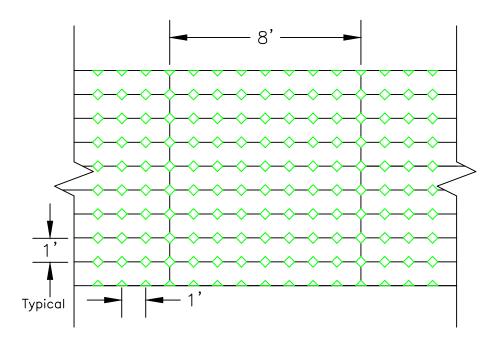


#### Notes:

- 1.) R-Shield MPS insulated concrete form.
- 2.) Premier ICF Ties. @ 12" o.c., each direction.
- 3.) Use Premier ICF Half Ties, at top and bottom of wall.
- 4.) Concrete wall thickness varies with Premier ICF Tie<sub>®</sub> size.
- 5.) Pour concrete in max. 4' vertical lifts for walls up to 8" thick and max. 2' vertical lifts for walls thicker than 8".
- 6.) R-Shield MPS boards are typically  $12" \times 96"$  (nominal).
- 7.) Field modifications to forms may be made provided the maximum unsupported MPS distance horizontally or vertically is 7".
- 8.) If field cutting MPS boards, install a Premier ICF Tie. @ all slot locations & joints, even if spaced closer than 12".
- 9.) Joints in MPS planks do not need to be staggered.
- 10.) Do not use cracked or damaged MPS planks or Premier ICF.
- 11.) Set factory cut corner pieces first. Build from corners to middle of wall, using field cut pieces as needed to complete wall.


### <u>Elevation</u>


Scale: NTS Updated 12-12-21


PREMIER ICF	
TITLE:	NO.
Typical Wall Elevation	PICF-000

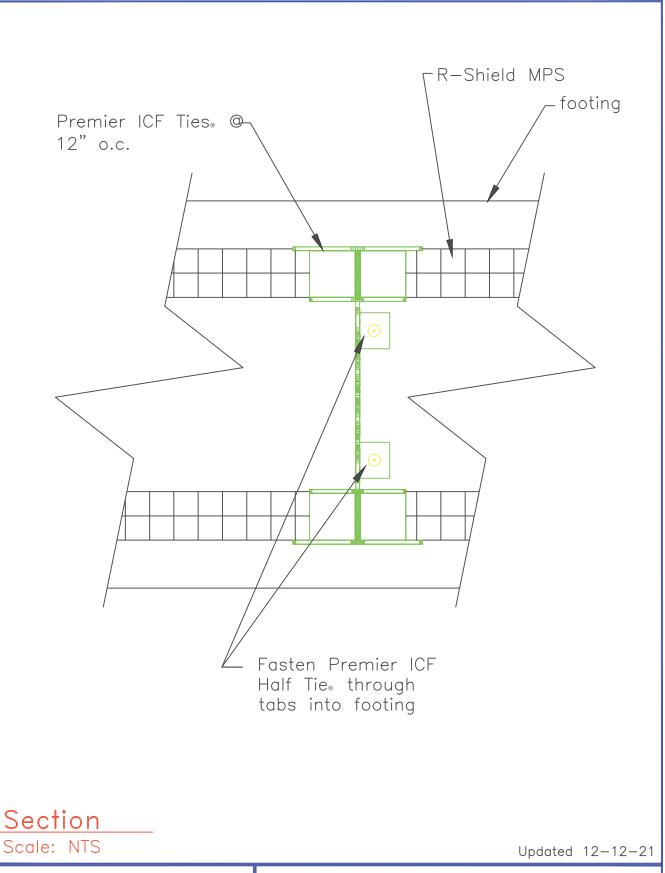


TITLE: Starter Course Half Tie to Footing NO. PICF-001

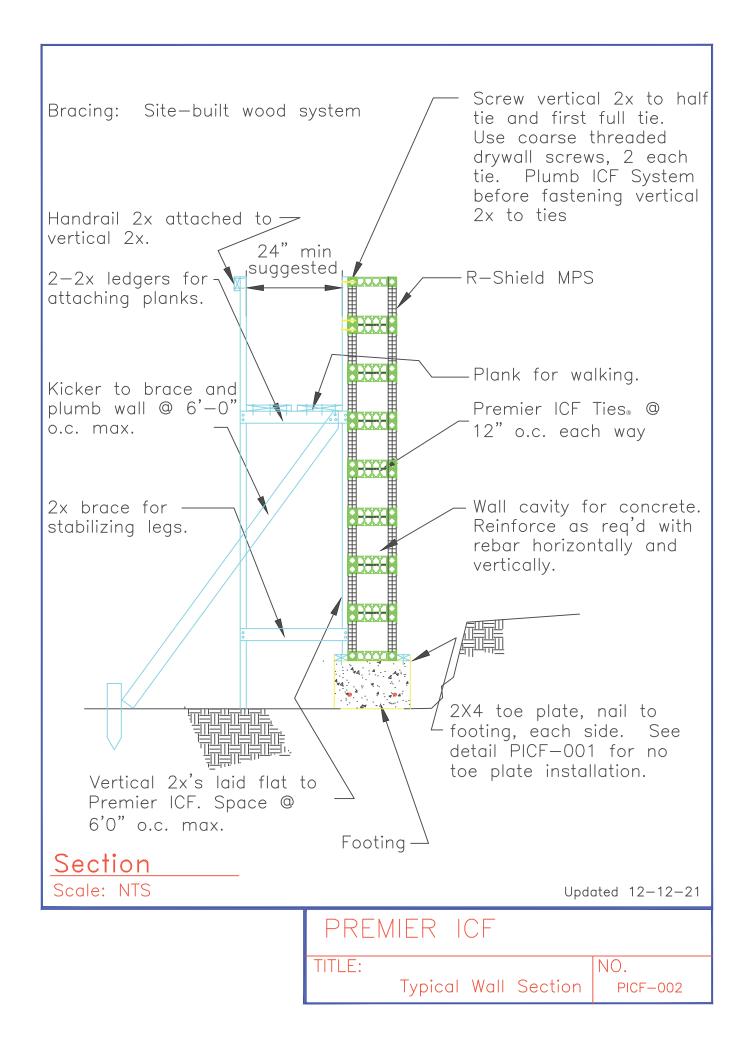

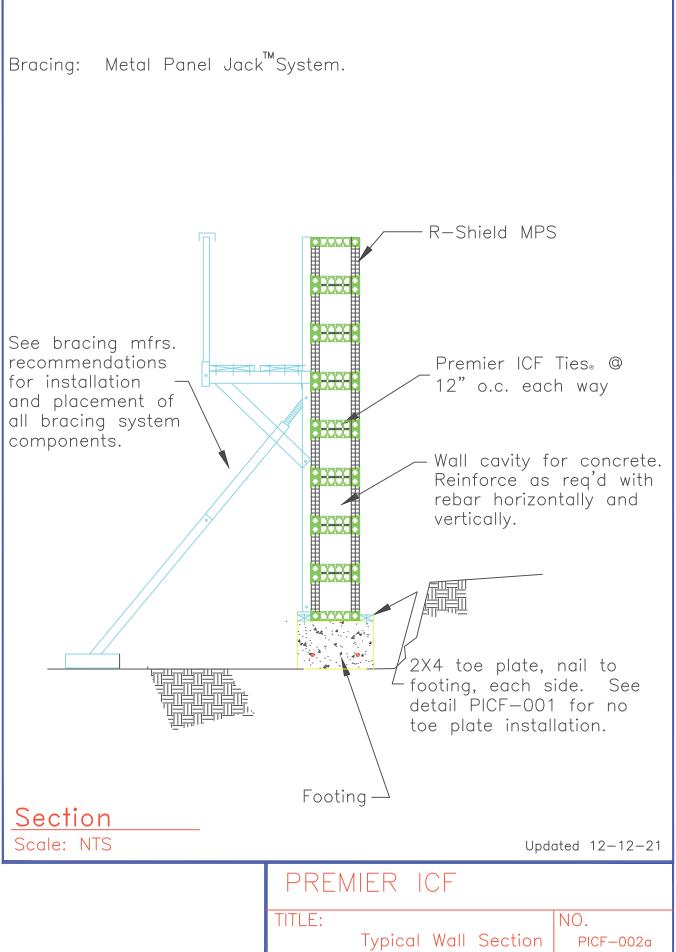


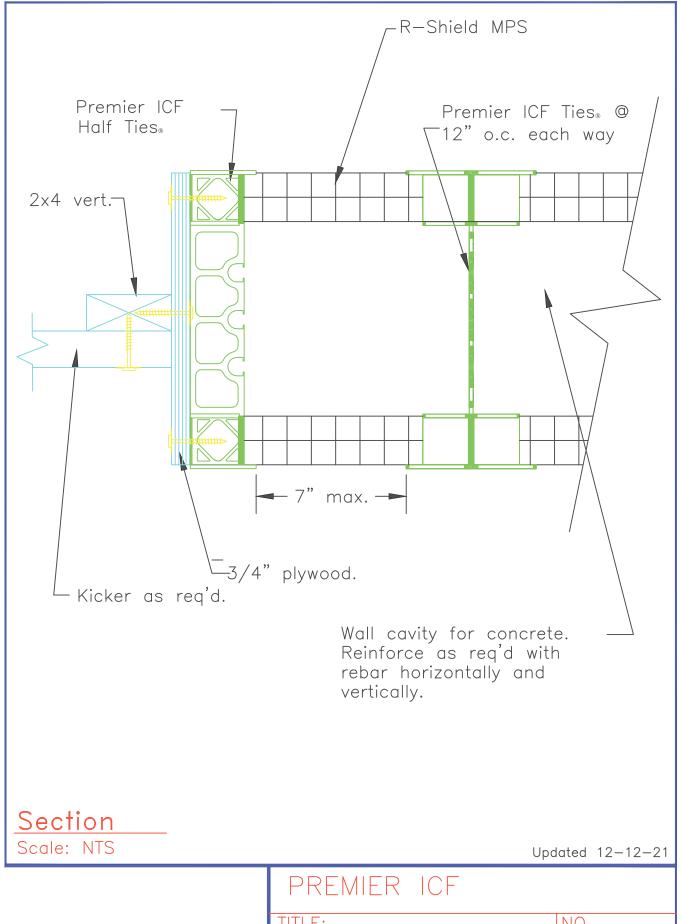


TITLE: NO. Wall Closure PICF-003

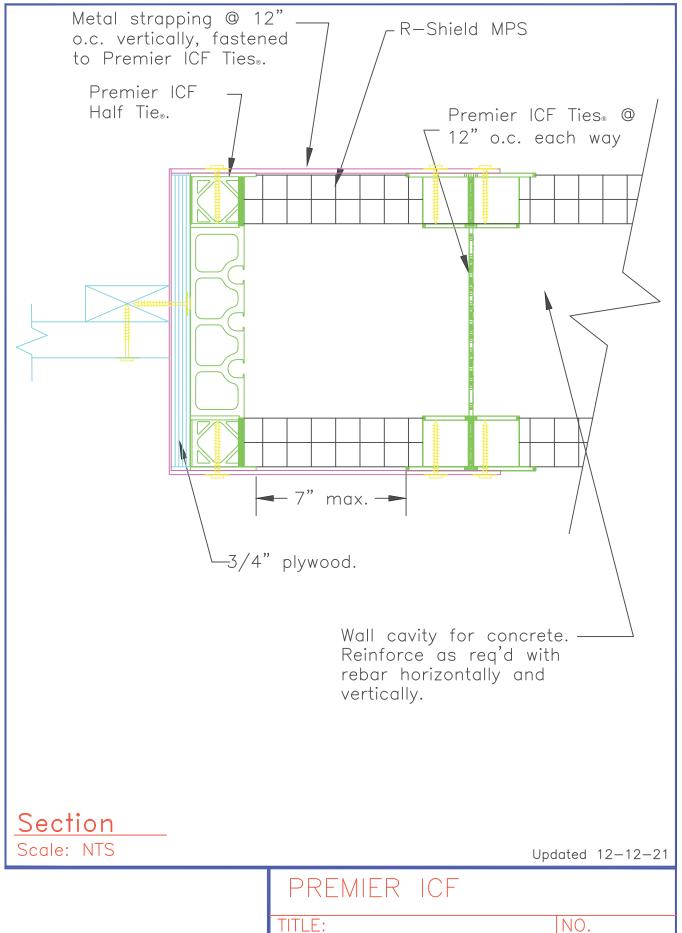


Wall Closure PICF-003a

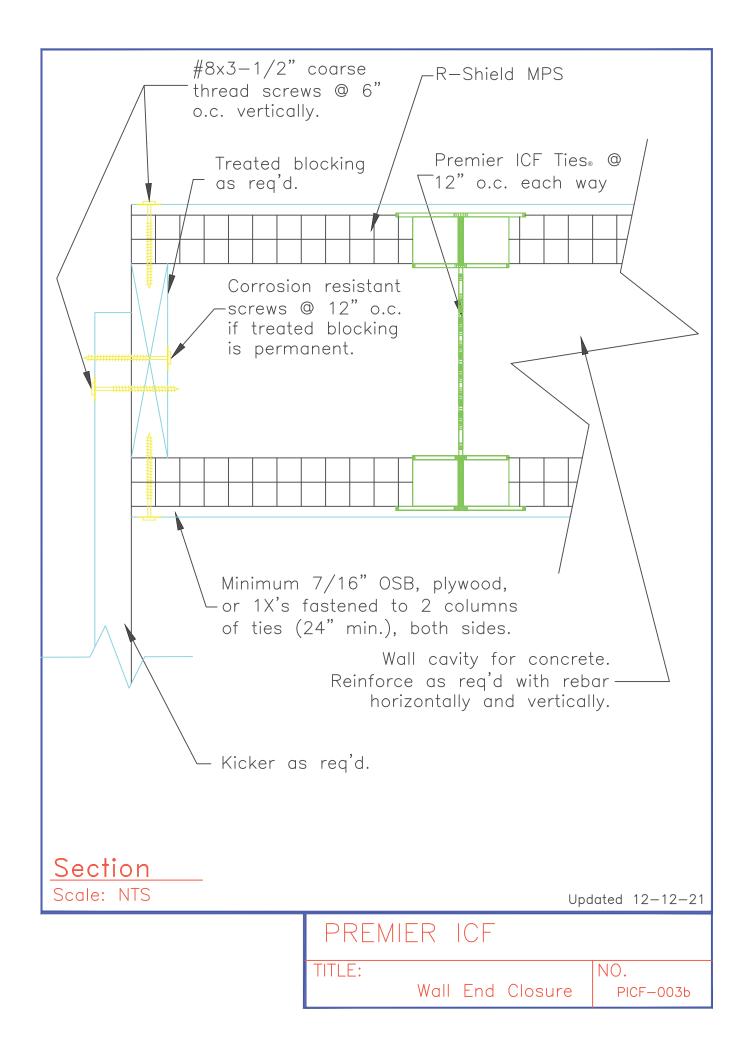


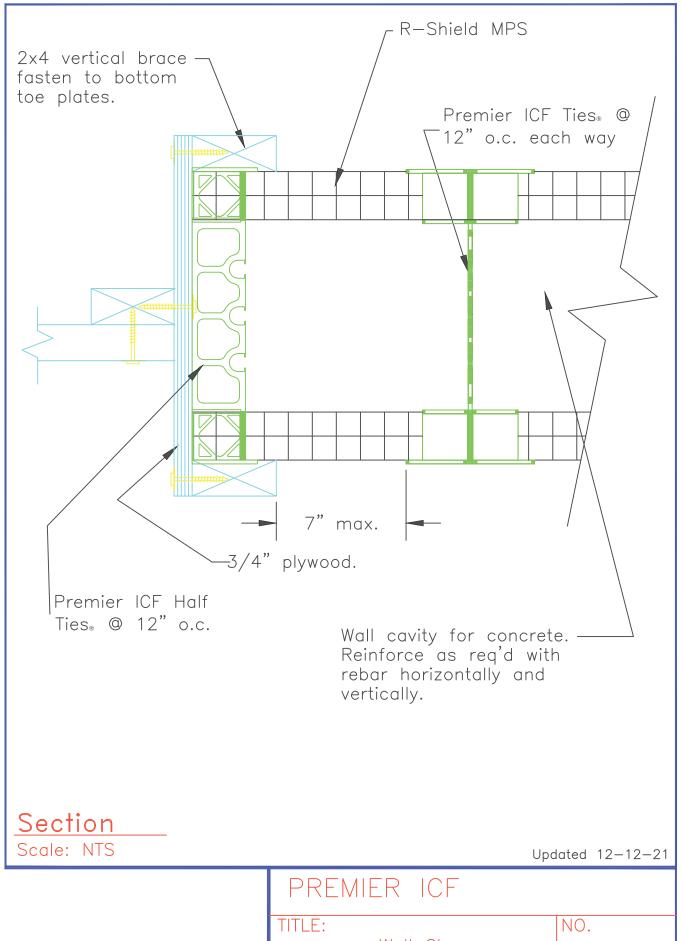


Wall Closure PICF-003c

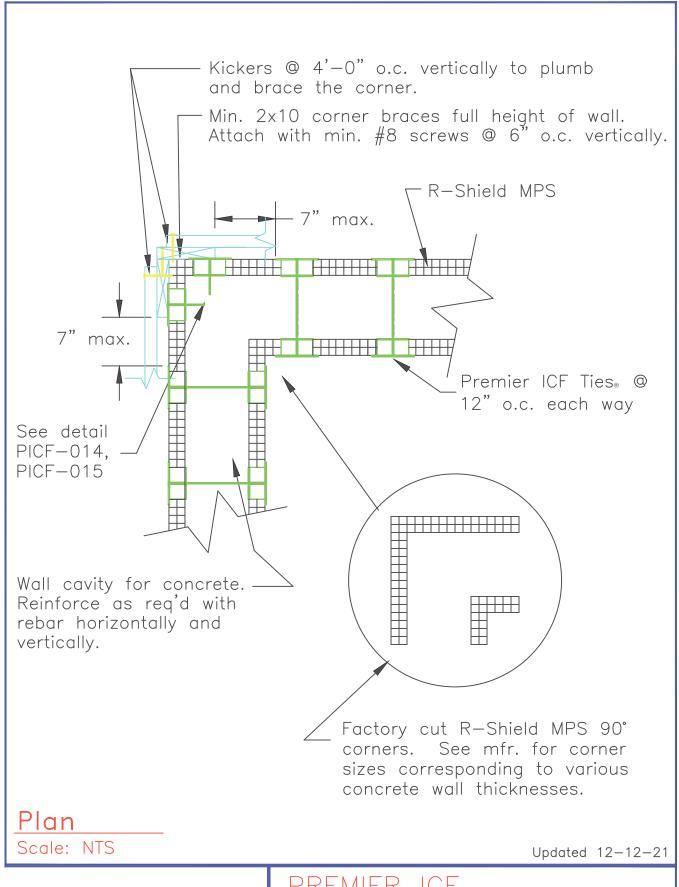


TITLE: Factory Precut 90° Corner Detail NO. PICF-004

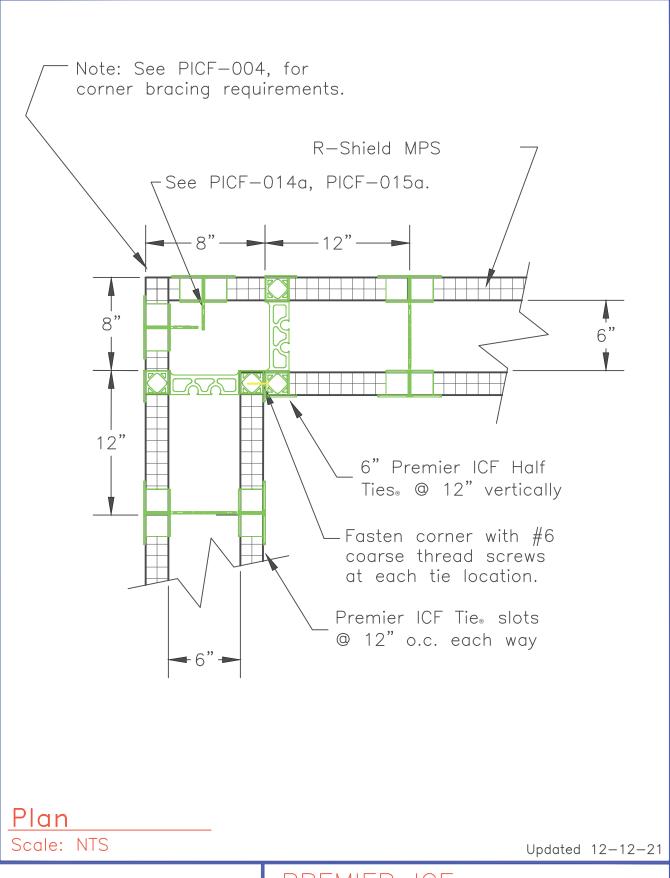


PRE	EMI	ER	ICF	
TITLE: 6"	Fly	Ву	Corner	NO. PICF-004a

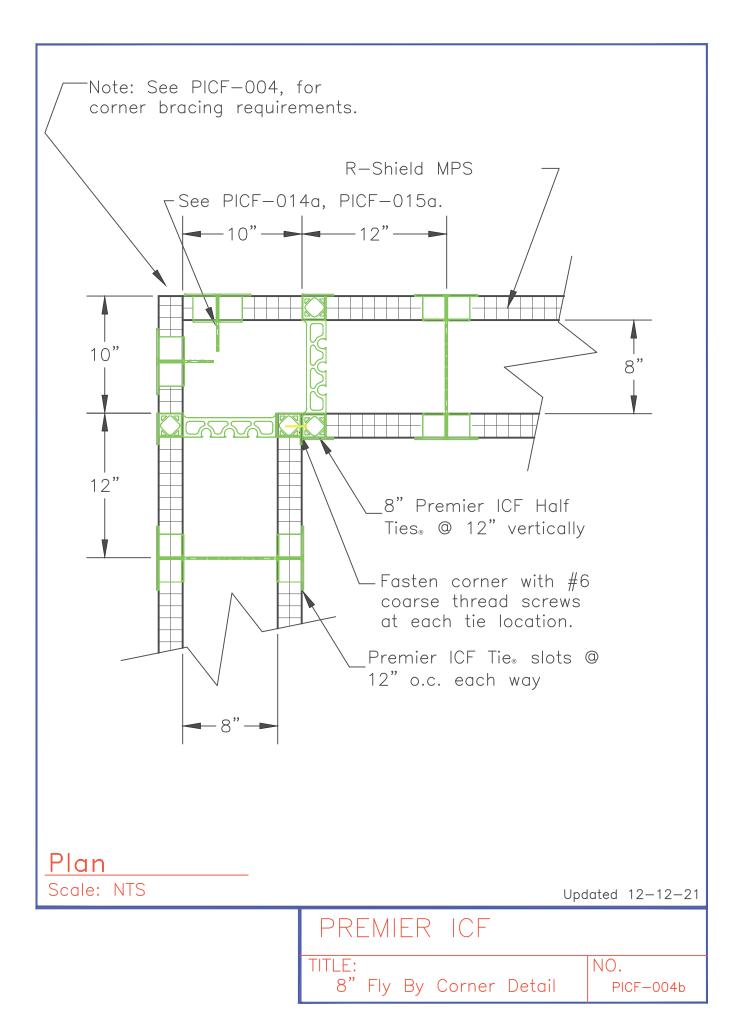


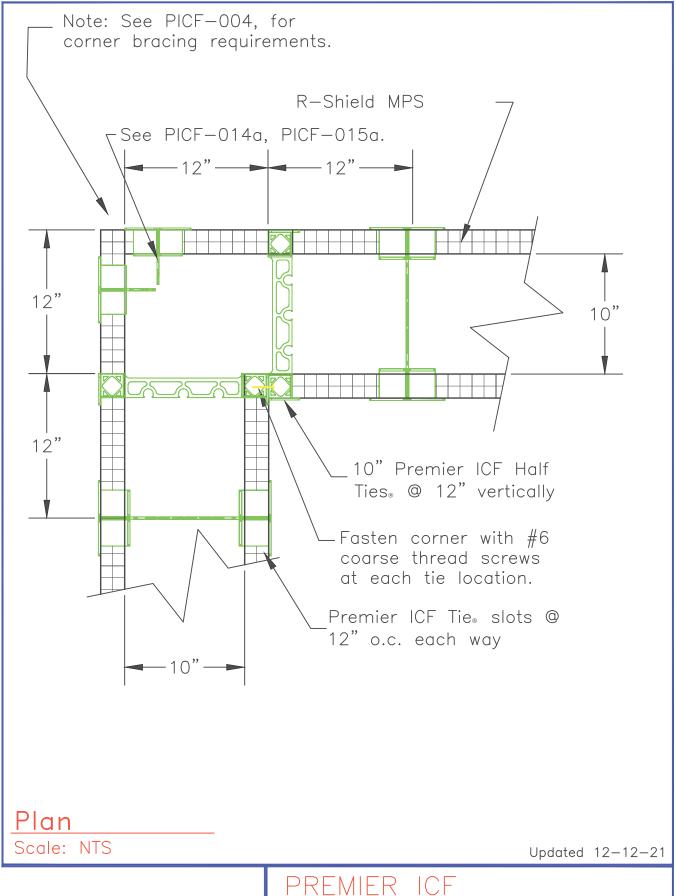

PRE	MIE	IR	ICF		
TITLE:					NO.
10"	Fly	Ву	Corner	Detail	PICF-004c

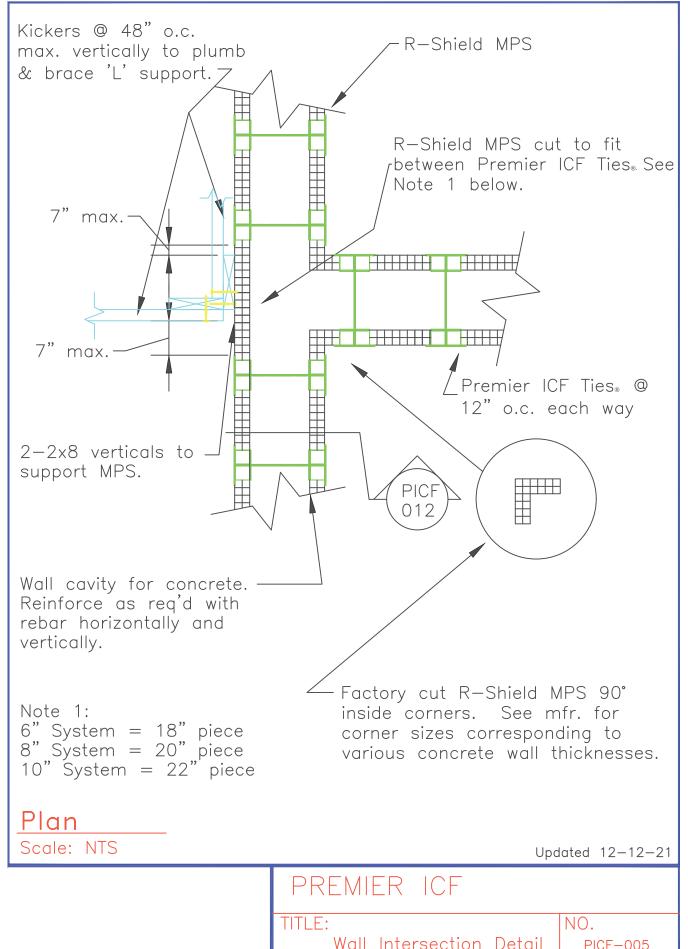


Wall Intersection Detail PICF-005

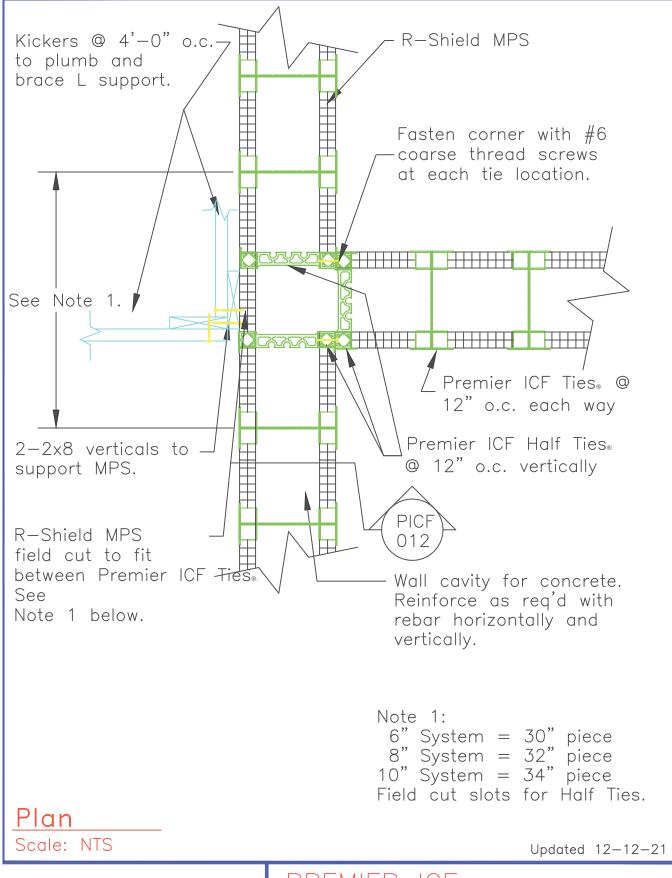


TITLE: Wall Intersection Detail NO.
Full Plank Option

PICF-005a

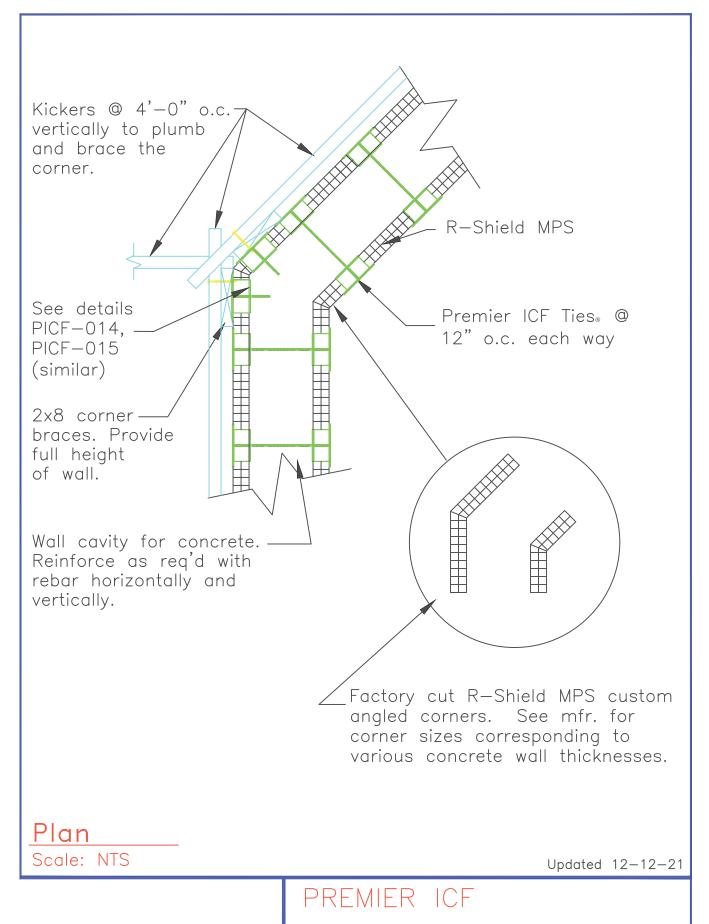

TITLE: Factory Precut 45° Corner Detail

NO. PICF-006

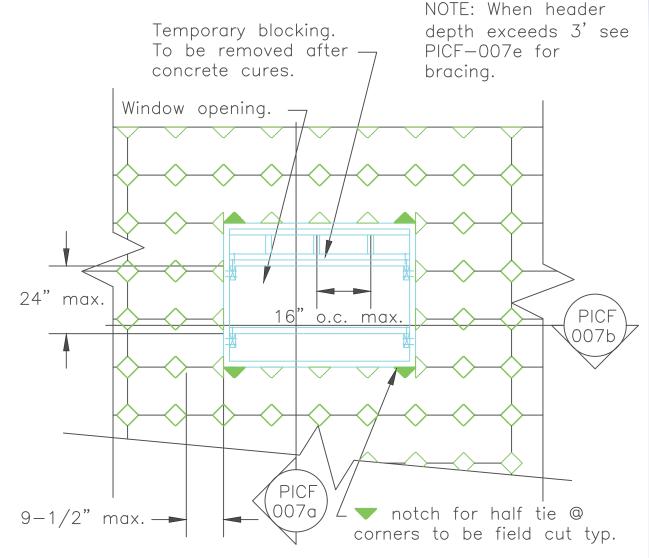


### Notes:

- 1.) See details PICF-007a & PICF-007b for closure detail around the opening.
- 2.) Provide horizontal & vertical bracing to support blocking at the top & sides of the opening as required by opening size & forces developed from the concrete pressure & weight.
- 3.) Where wood blocking is to remain in place around the opening, use treated lumber.
- 4.) Once concrete is up to the level of the sill, screed off.
- 5.) Vinyl bucks may require different bracing. Follow vinyl buck manufacturer's installation recommendations.

## Elevation


Scale: NTS Updated 12-12-21

PRE	MIER	ICF	
TITLE:	Window	Blockout	NO. PICF-007

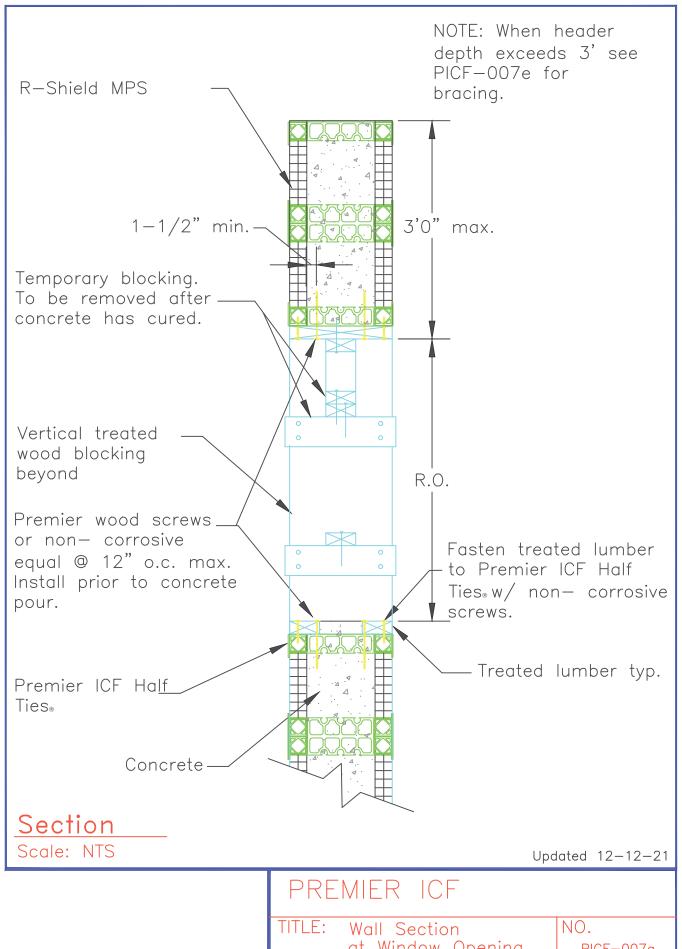

at Window Opening

PICF-007a

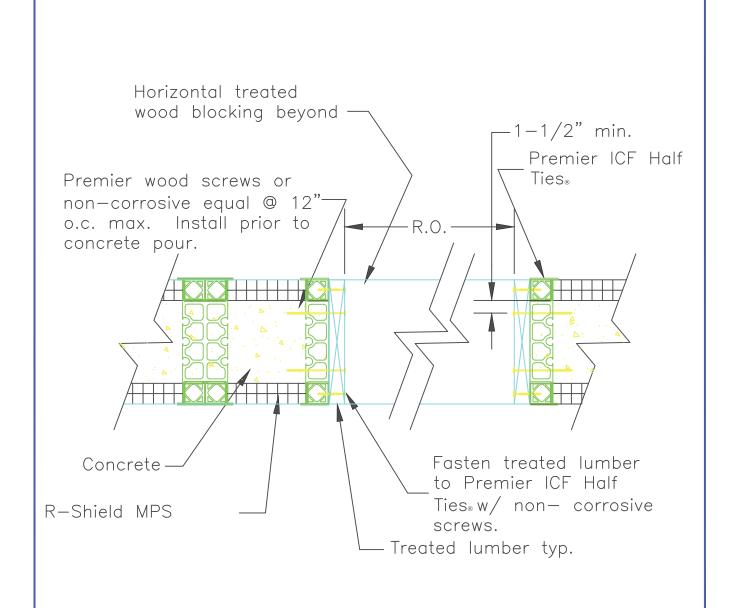


Section

Scale: NTS Updated 12-12-21

PREMIER ICF

TITLE: Wall Section at Window/Door Opening

NO. PICF-007b

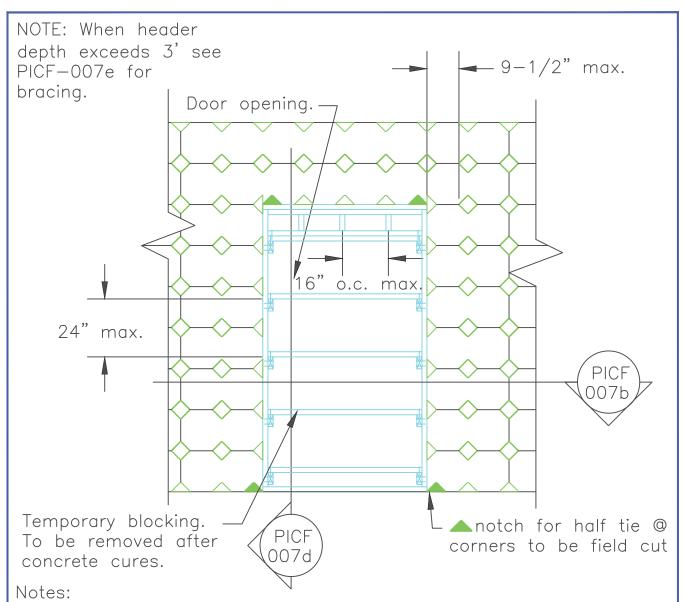


- 1.) See details PICF-007b & PICF-007d for closure detail around the opening.
- 2.) Provide horizontal & vertical bracing to support blocking at the top & sides of the opening as required by opening size & forces developed from the concrete pressure & weight.
- 3.) Where wood blocking is to remain in place around the opening, use treated lumber.
- 4.) Vinyl bucks may require different bracing. Follow vinyl buck manufacturer's installation recommendations.

E	le	٧	a	ti	0	n			
									Ī


Scale: NTS Updated 12-12-21

PREMIER ICF	
TITLE: Door Blockout	NO. PICF-007c

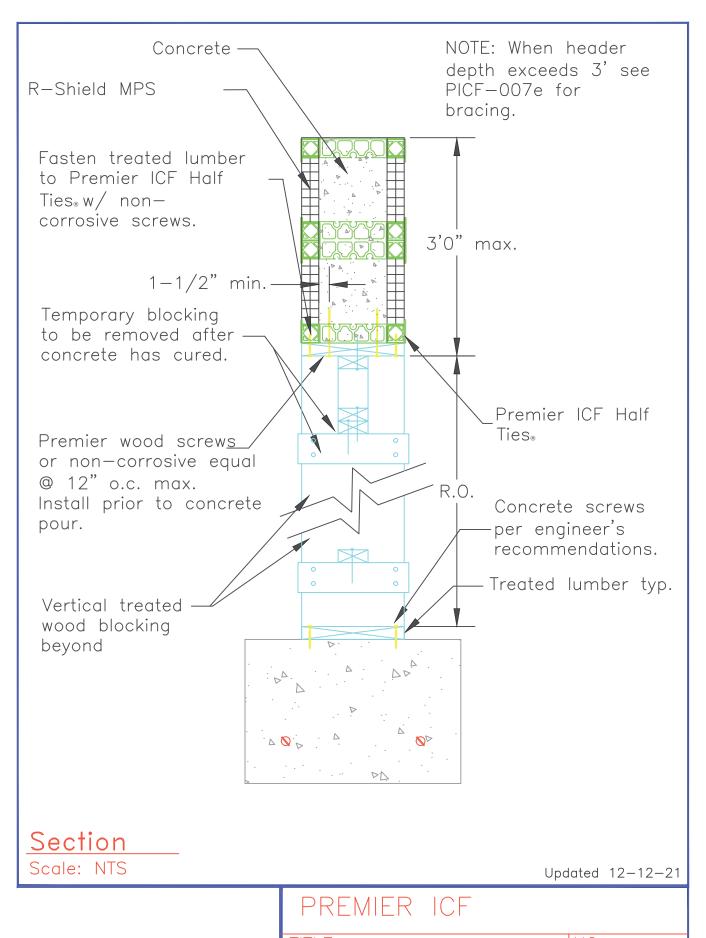



TITLE: Wall Section at Door Opening


NO. PICF-007d

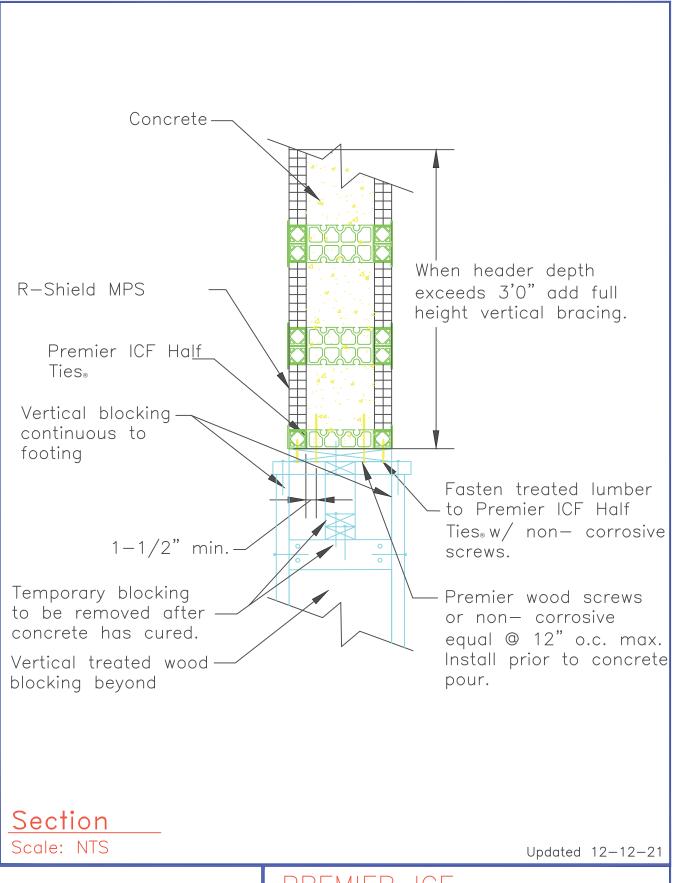



TITLE: Header Section at Window/Door Opening NO. PICF-007e

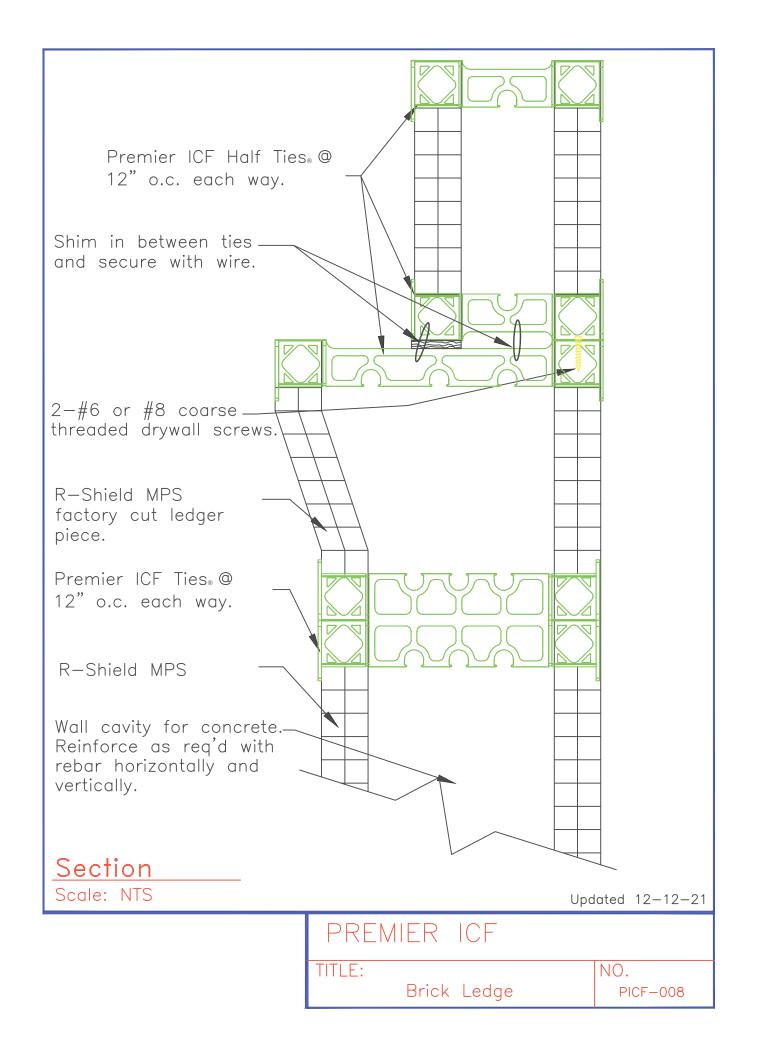


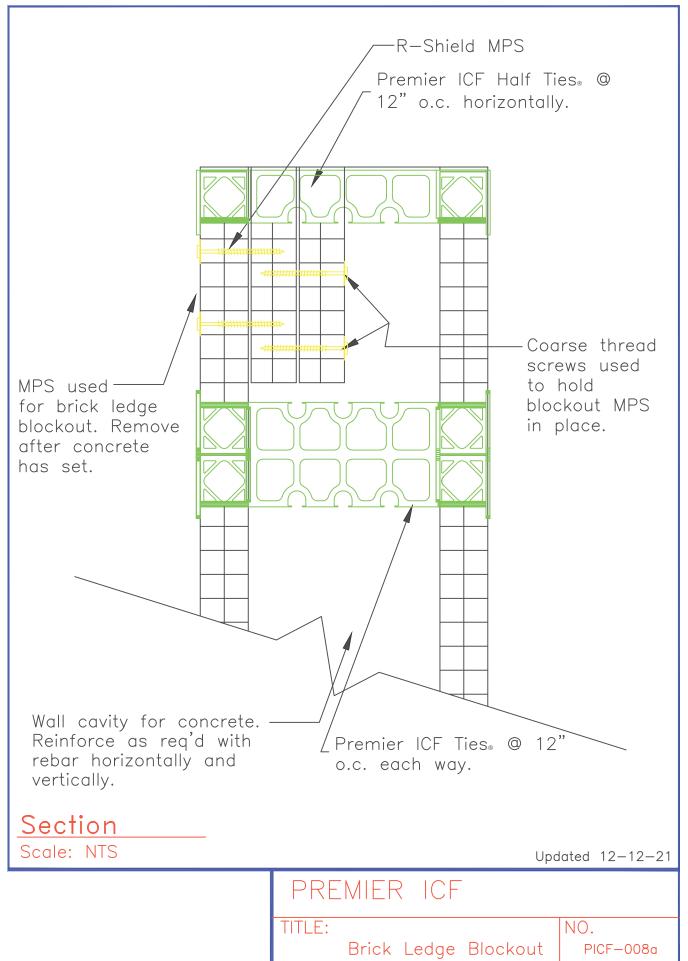

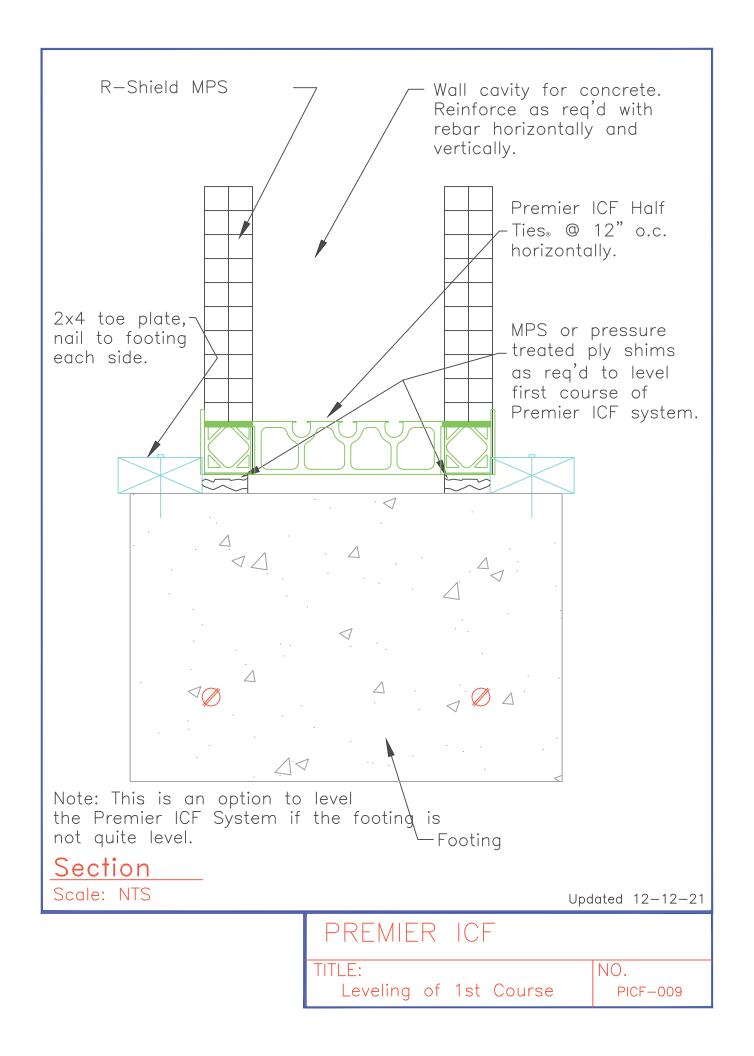

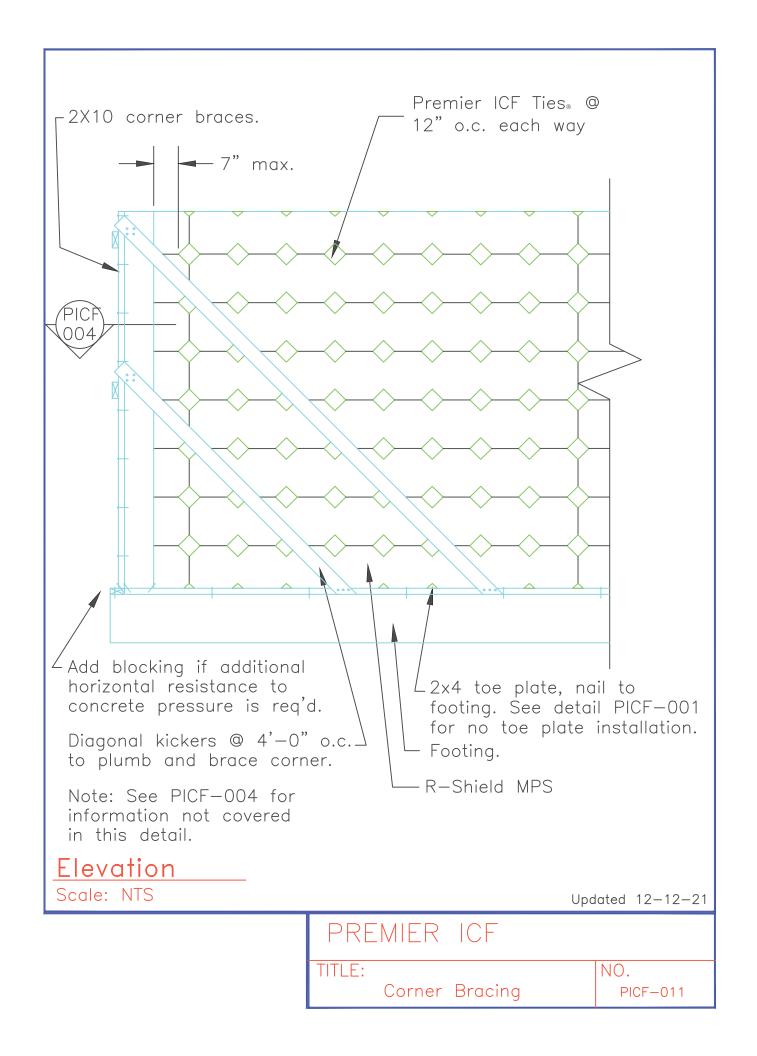


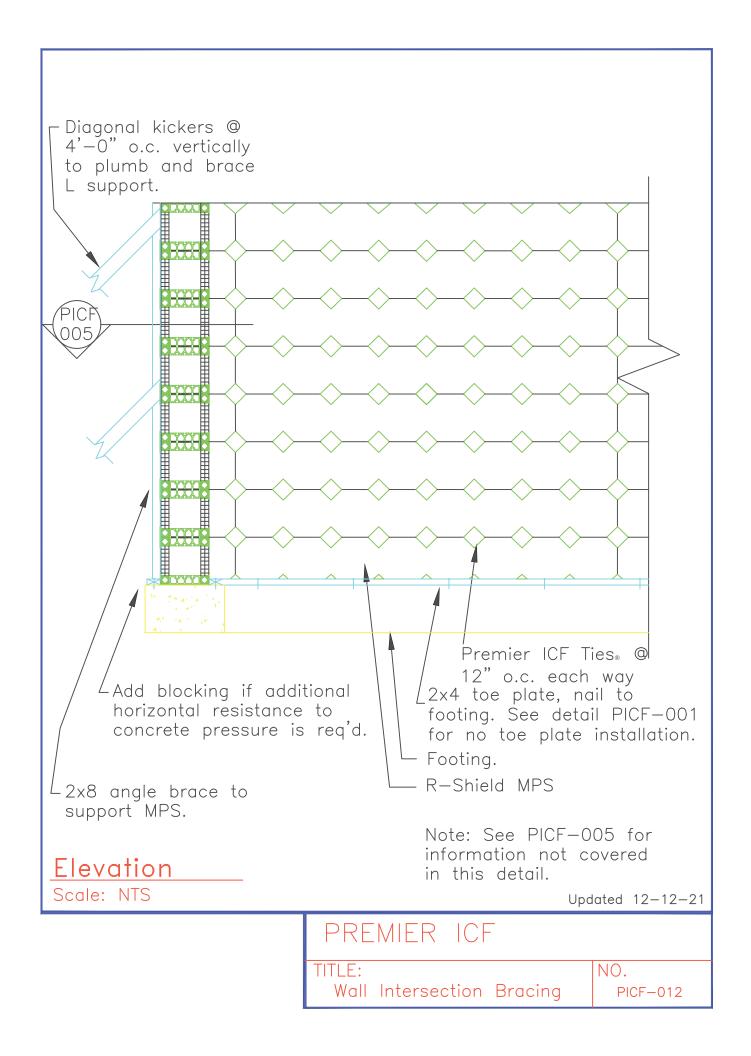

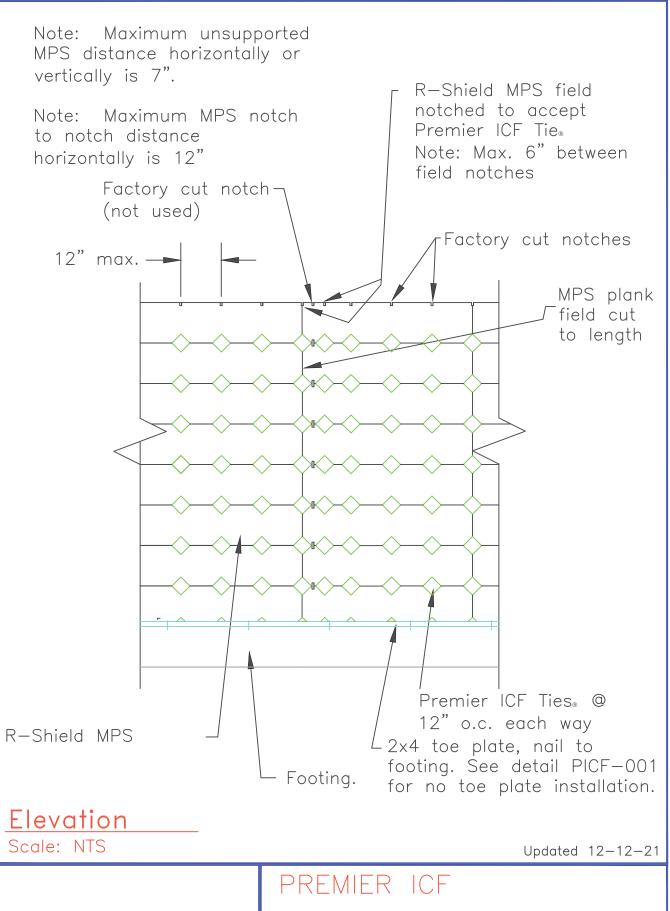

TITLE: Mid Wall Diamond Snap-Tie Placement

NO. PICF-012a

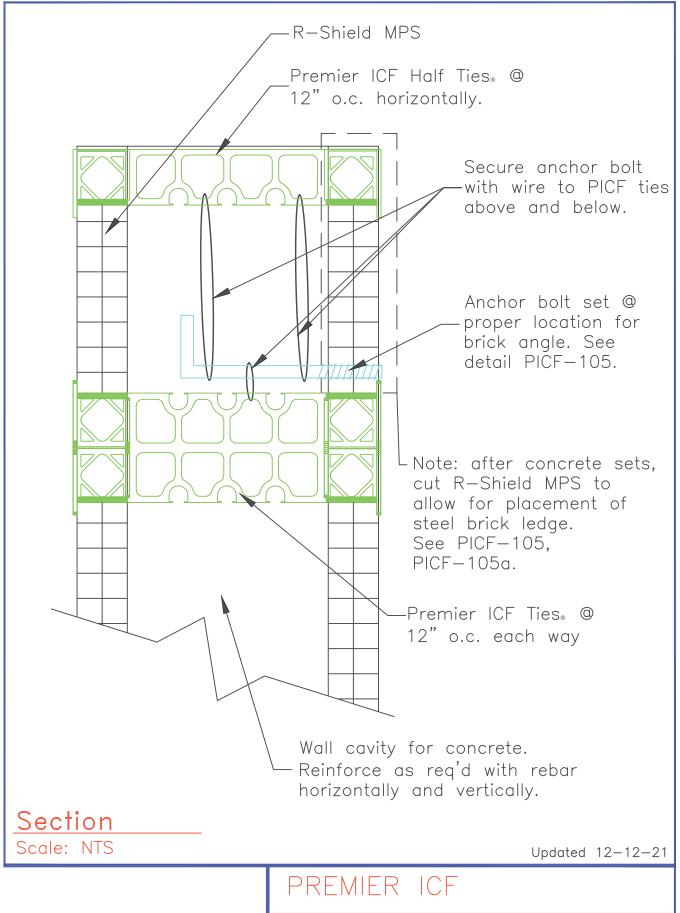



TITLE:


NO.


Brick Ledge Angle Anchorage


PICF-013

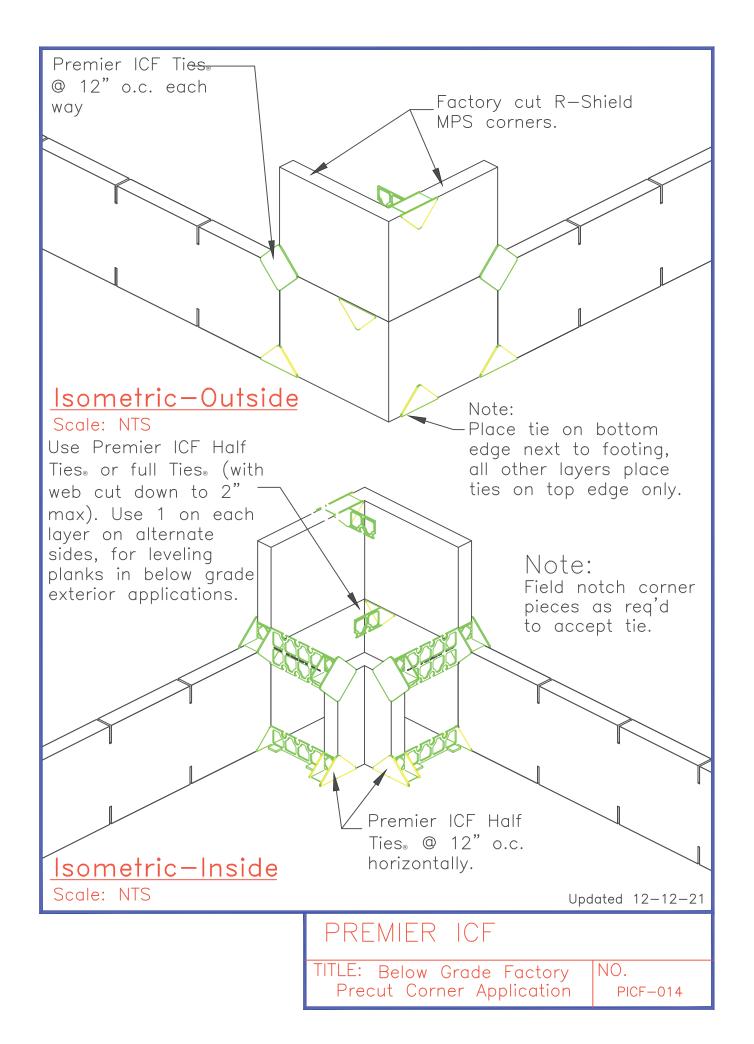

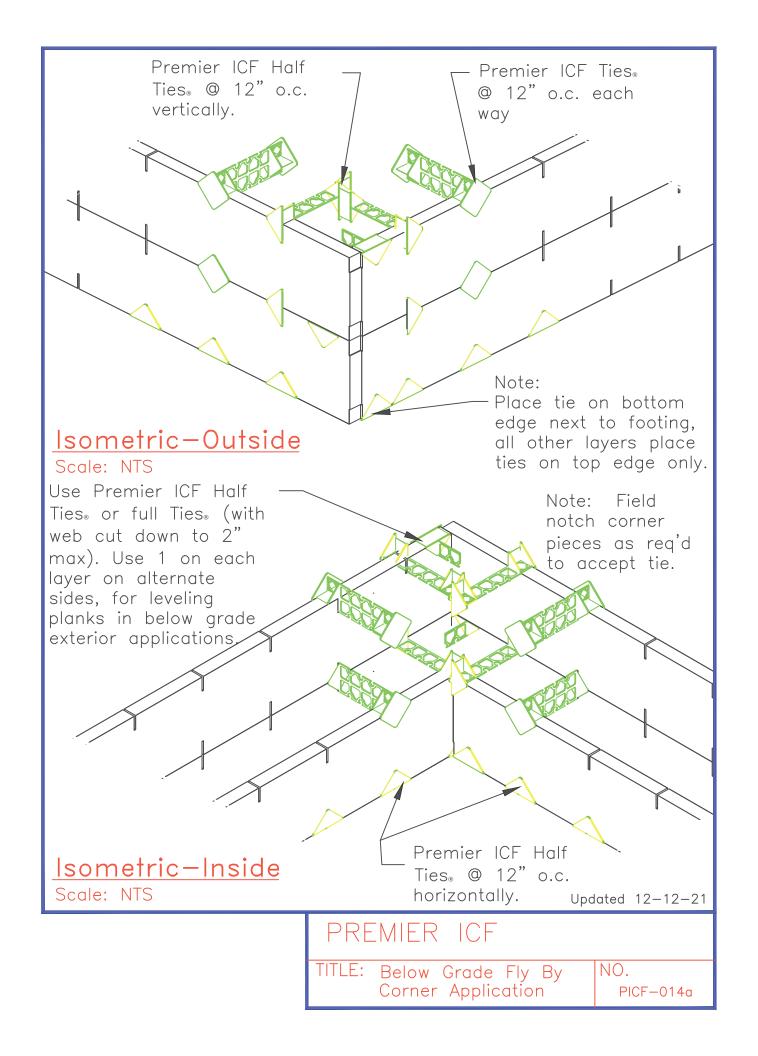


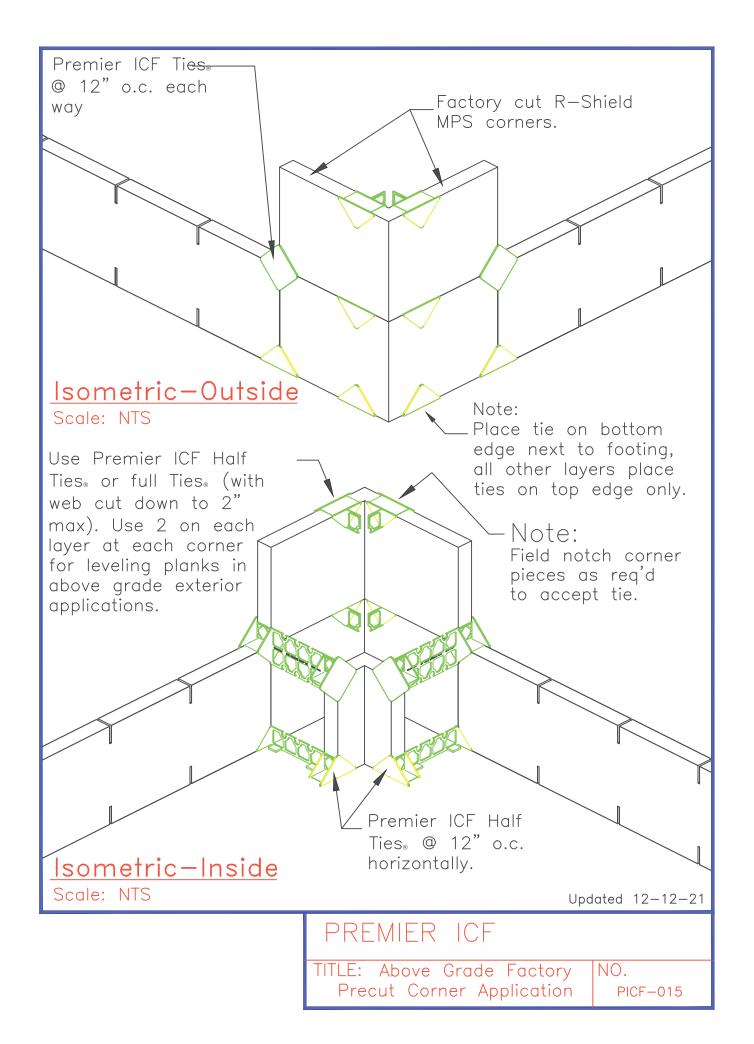


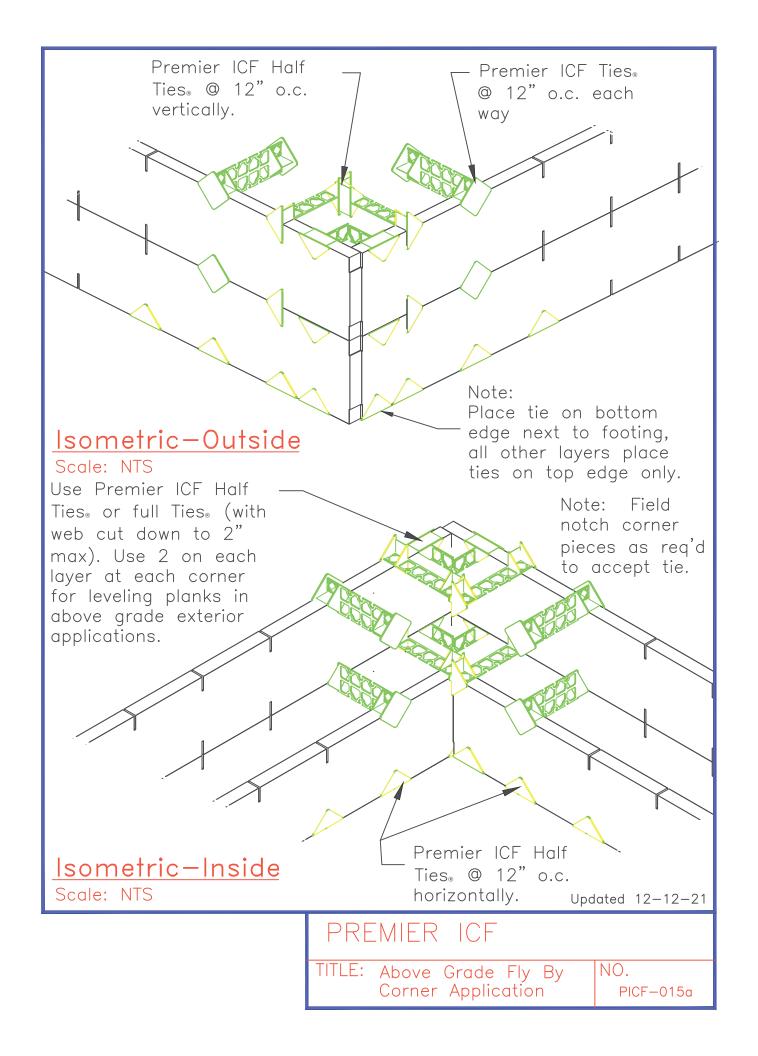

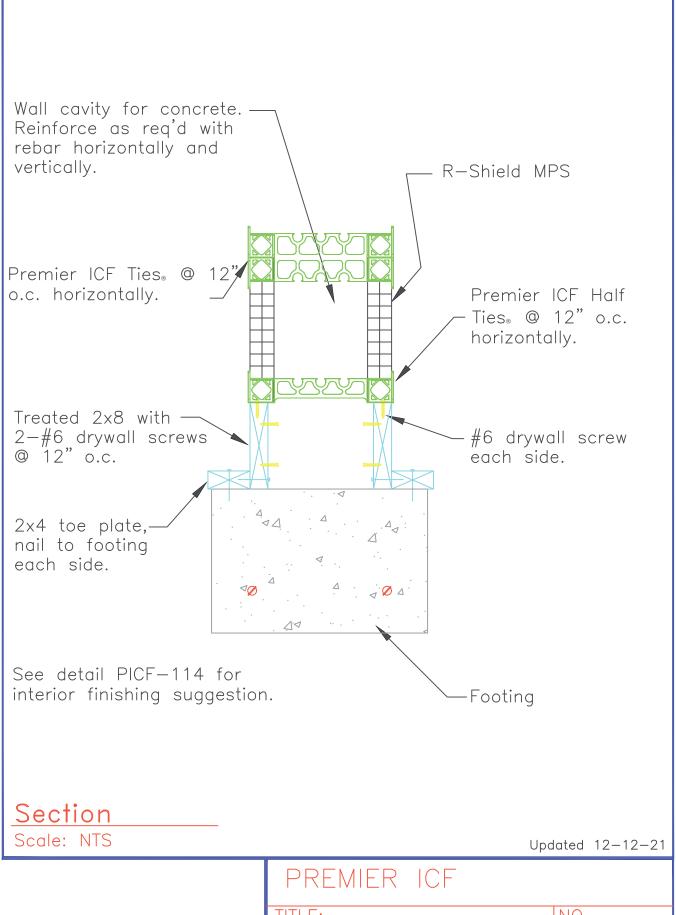

TITI F: NO. Baseboard Attachment PICF-017

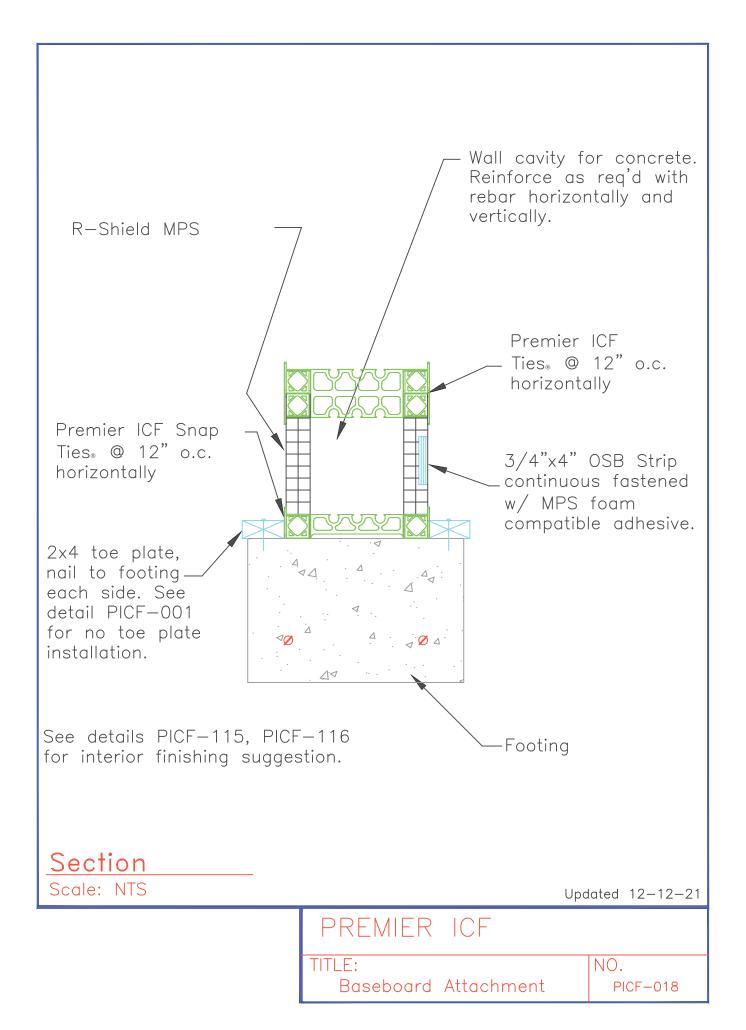

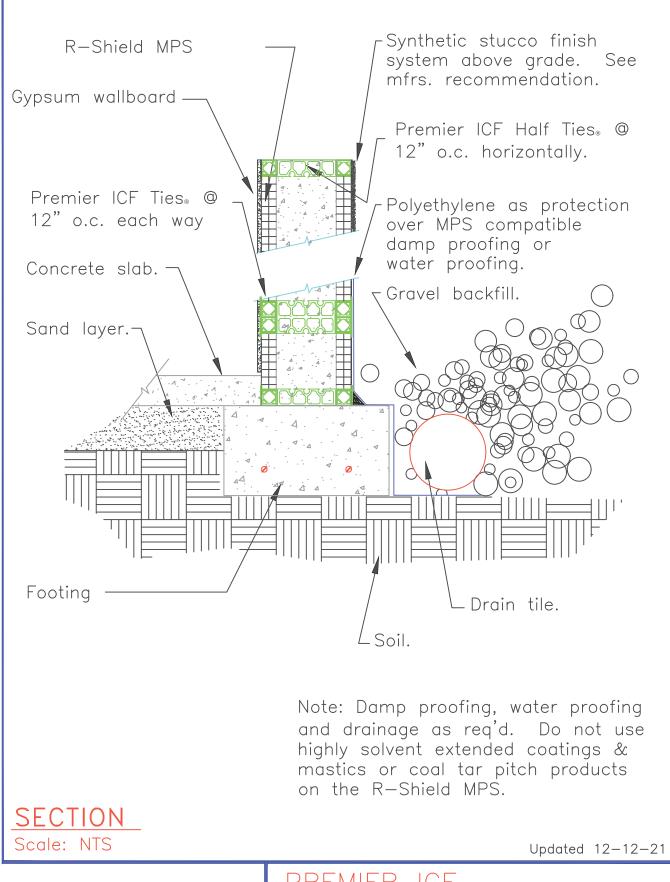


TITLE:

Typical Section — Finishes


NO.

PICF-100

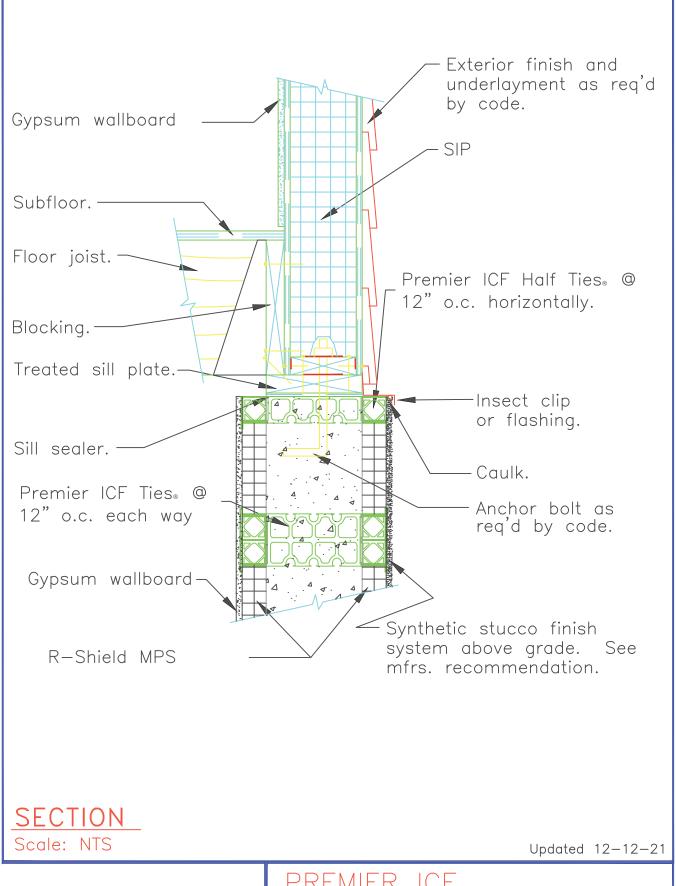

PREMIER ICF

TITLE: NO. PICF-101

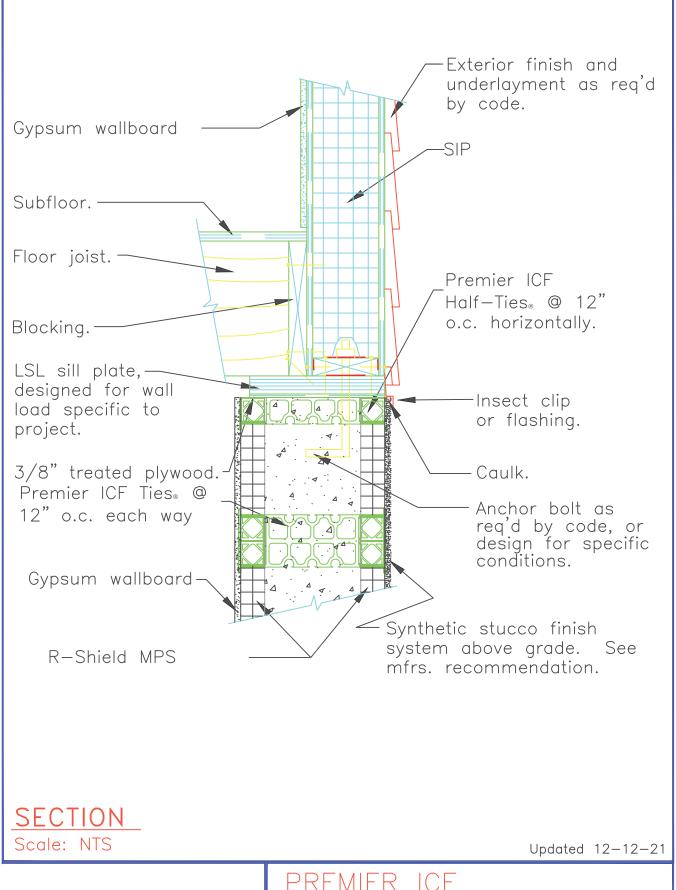


PREMIER	ICF

TITLE:

Concrete Wall / Sill Plate


NO.

PICF-102

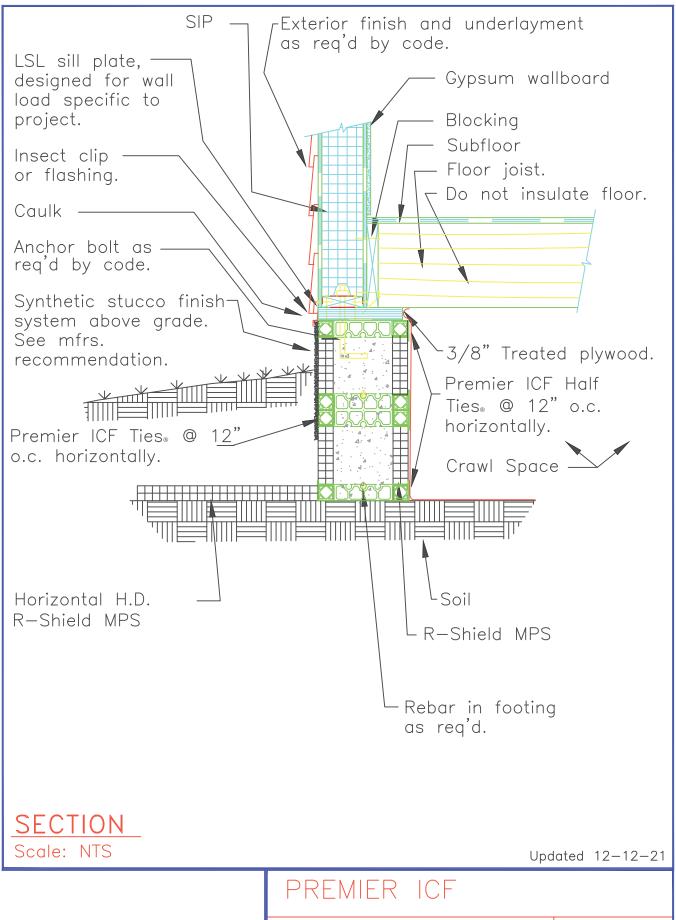

PREMIER ICF


TITLE: NO. PICF-103

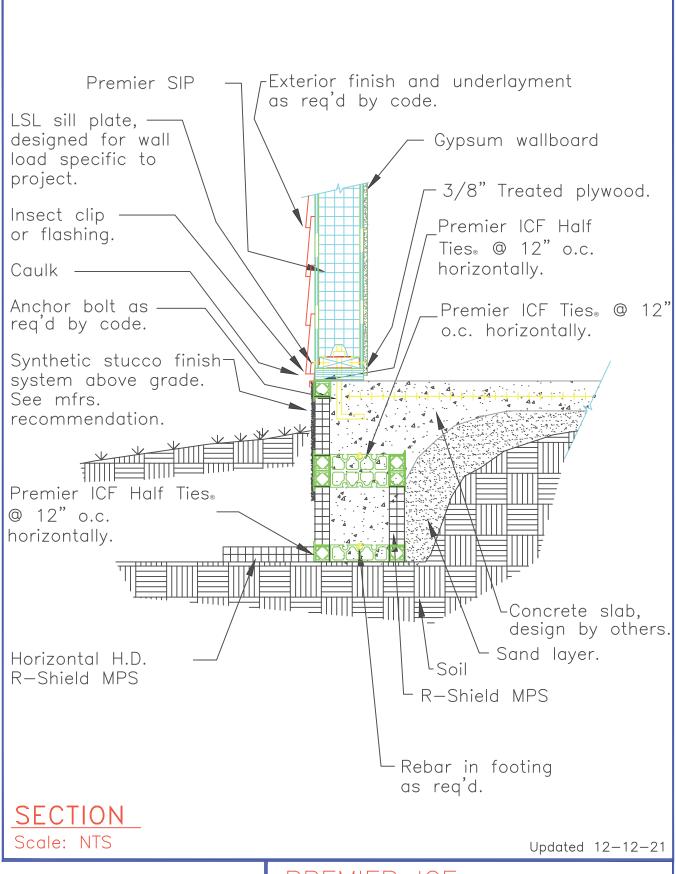


## PREMIER ICF

TITLE: Monolithic Slab/Shallow NO. Footing using DSF


NO. PICF-104

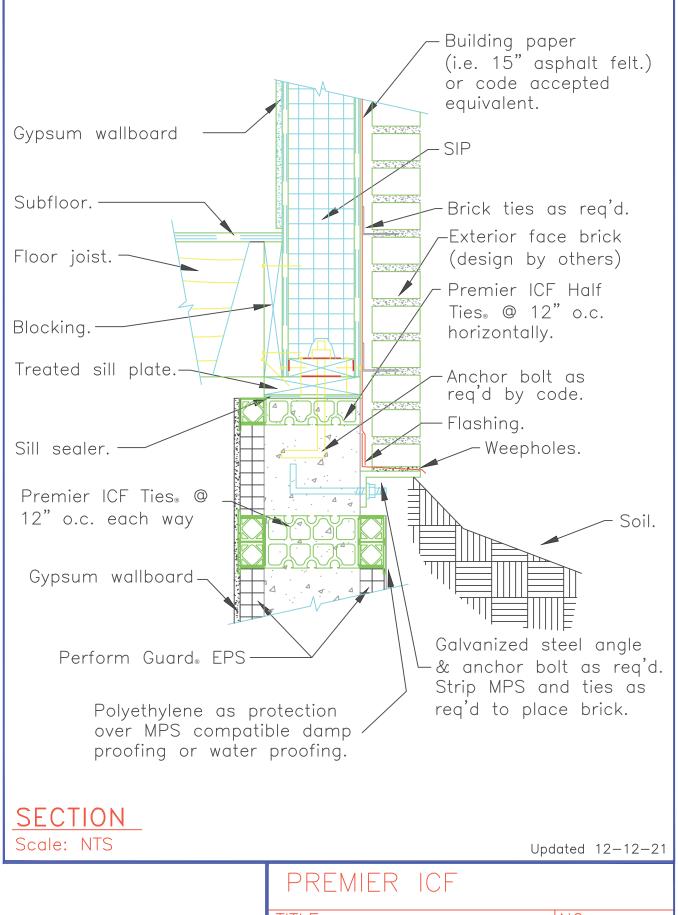



PREMIER ICF	
TITLE:	NO.
Brick Angle Anchorage	PICF-105

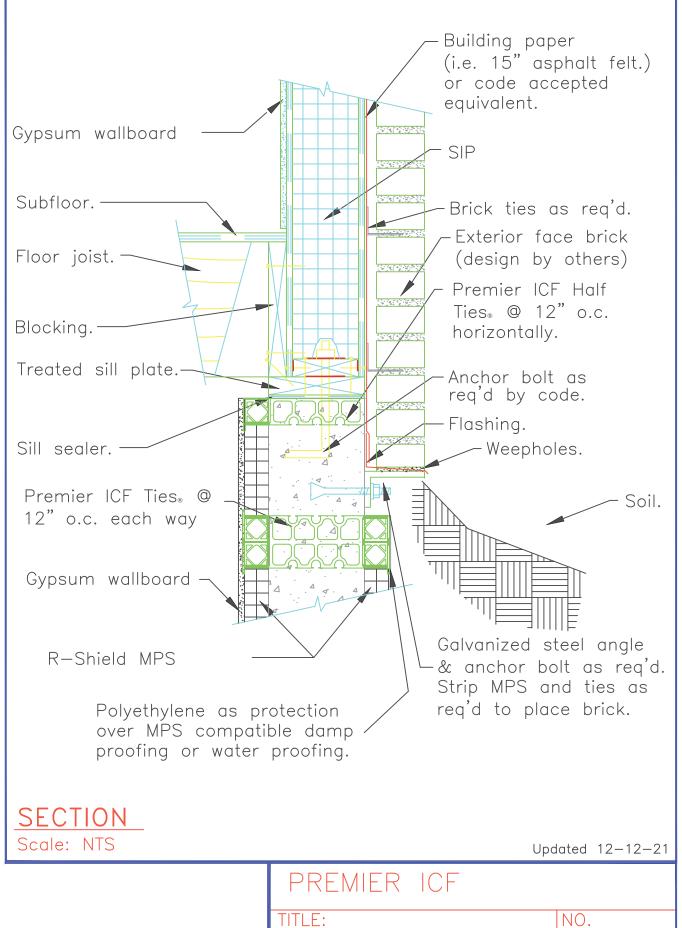

Brick Angle Anchorage PICF-105a

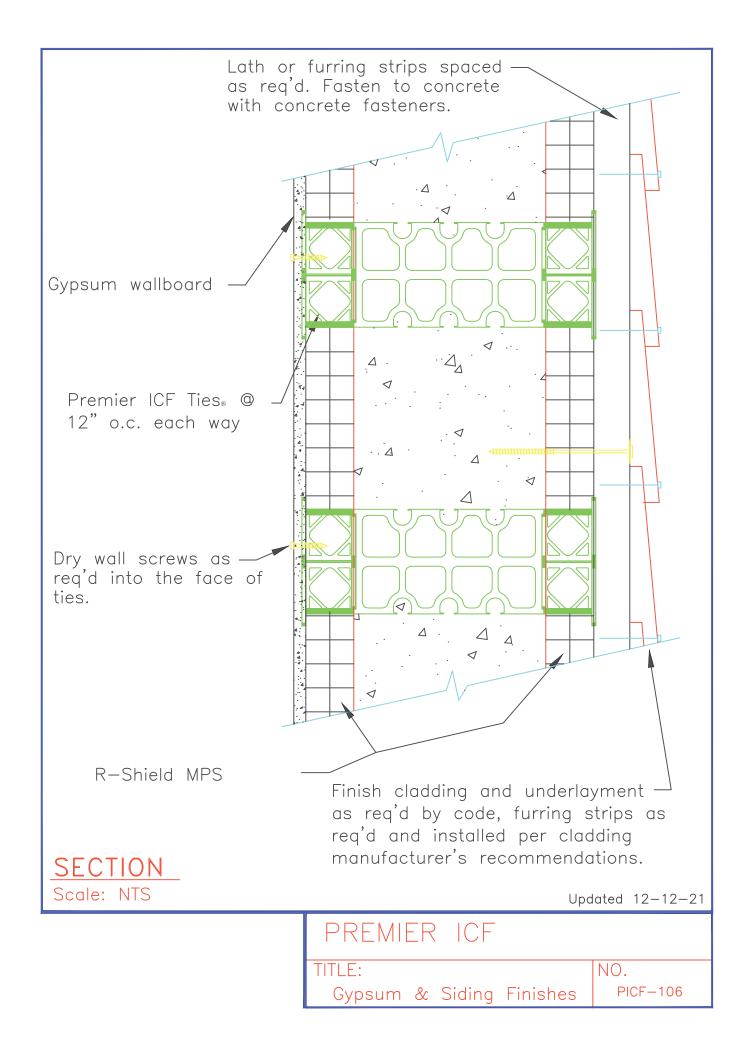


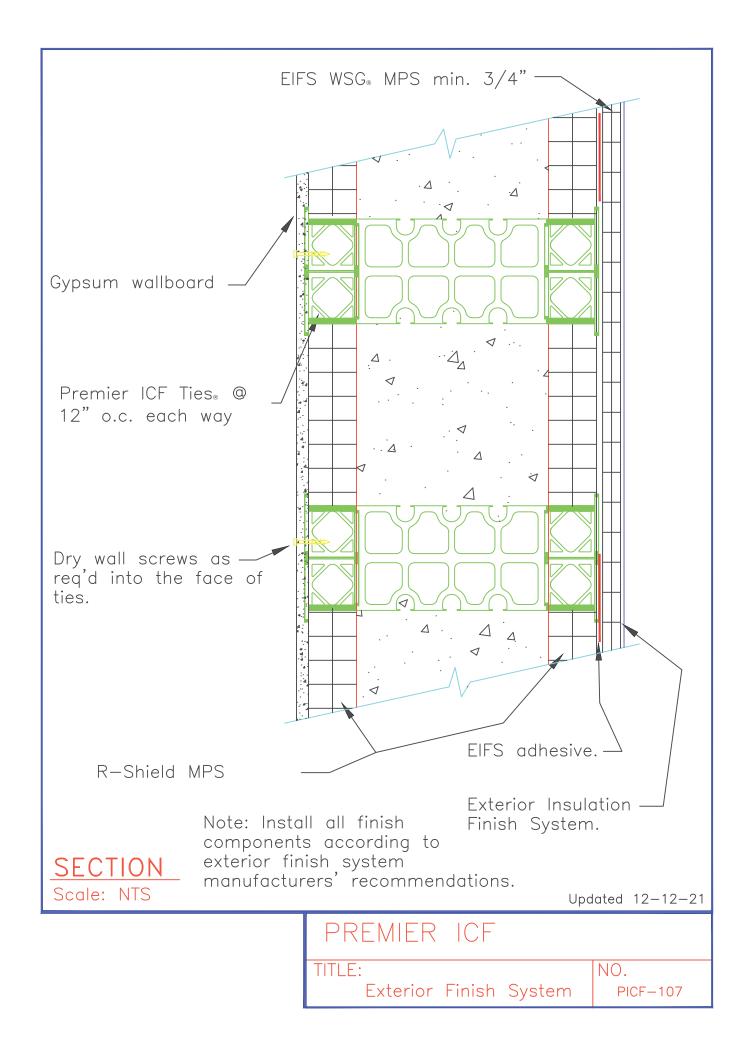

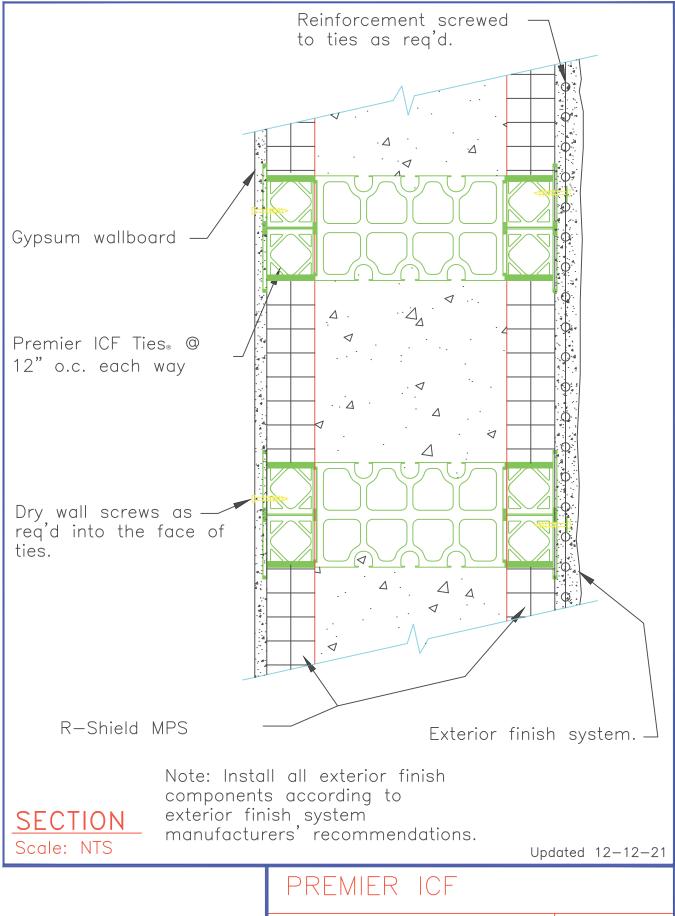


PREMIER ICF


TITLE: NO. PICF-107a

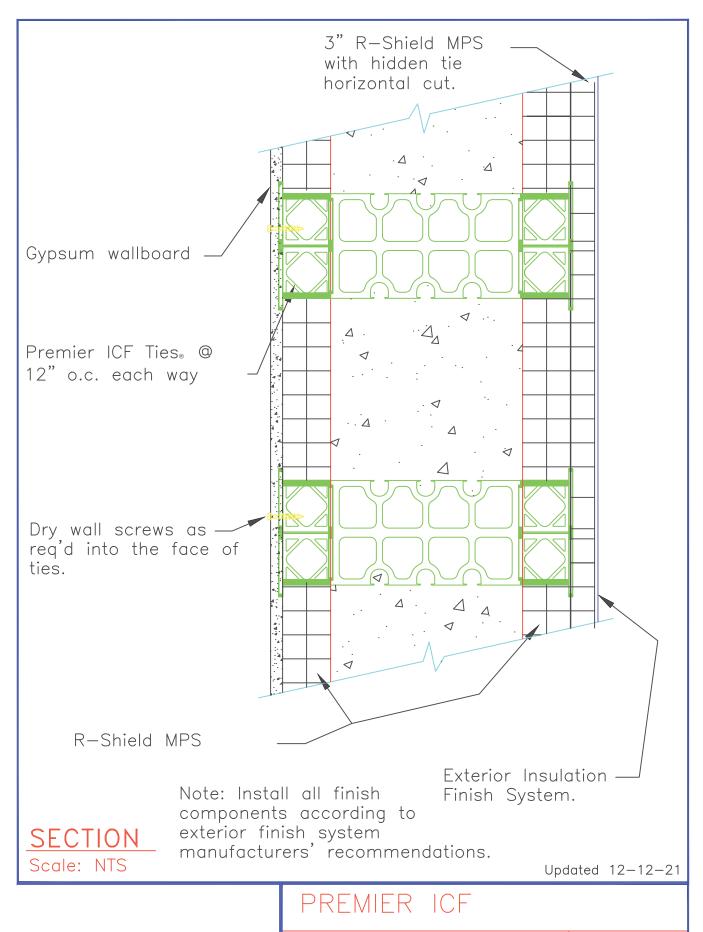


TITLE: Hidden Tie Exterior Finish System

NO. PICF-107b

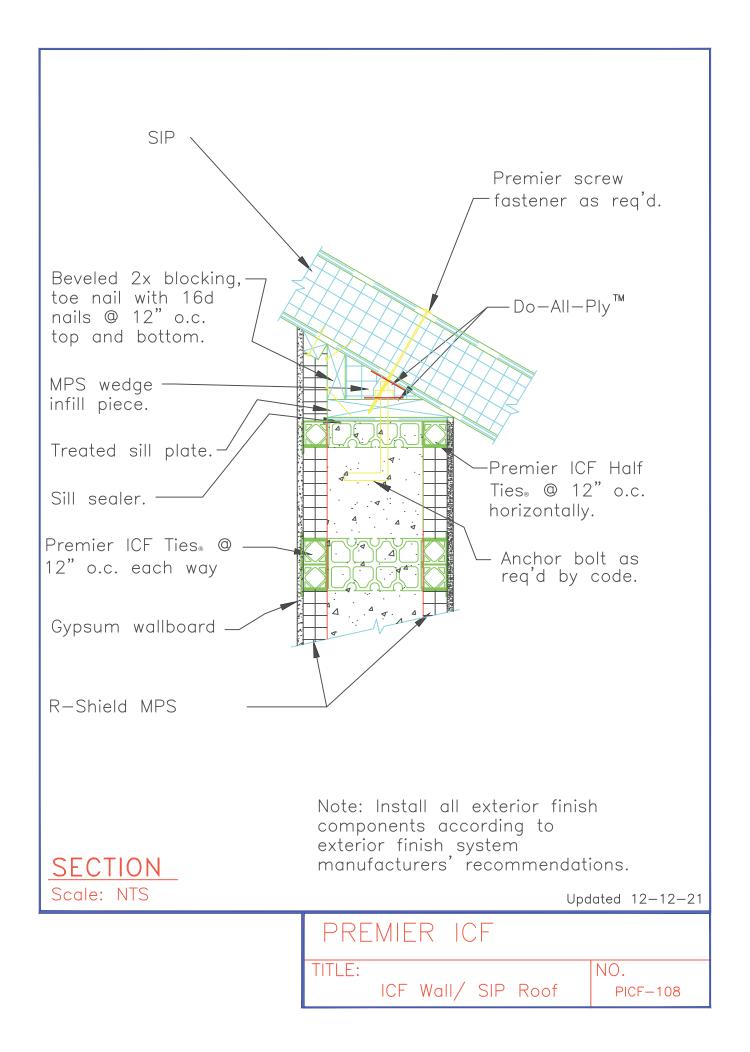

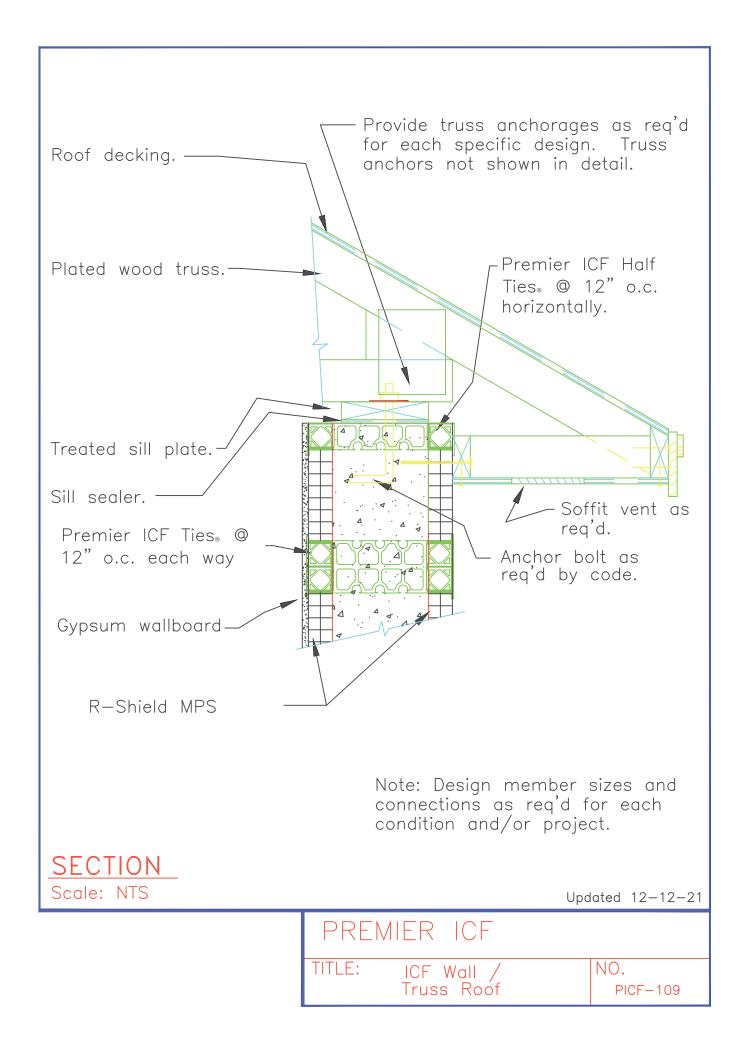

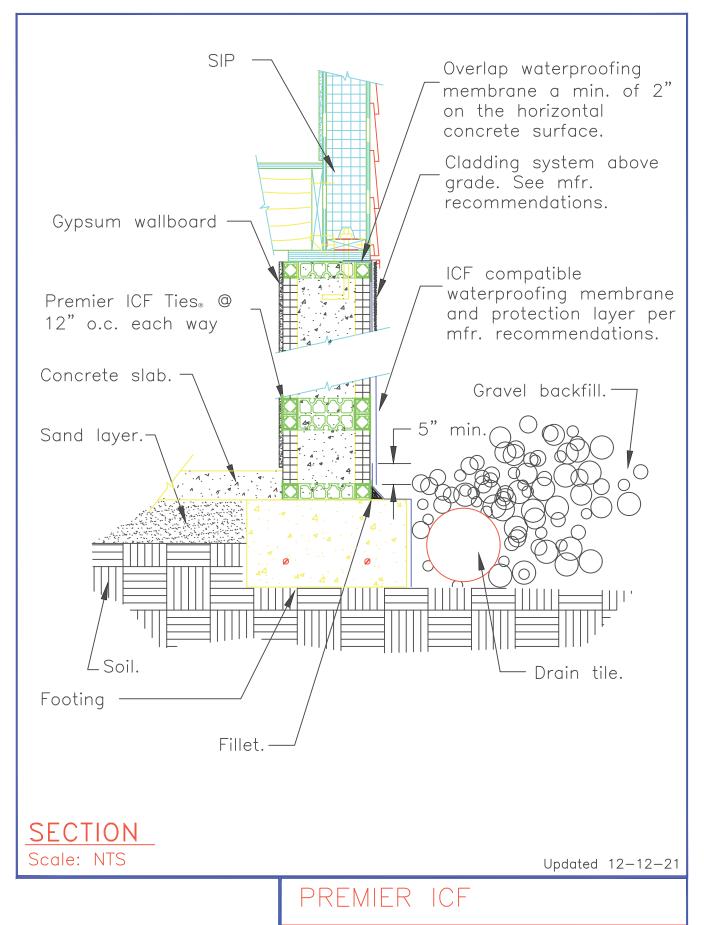


TITLE:

ICF Sheet Waterproofing


NO.

PICF-110

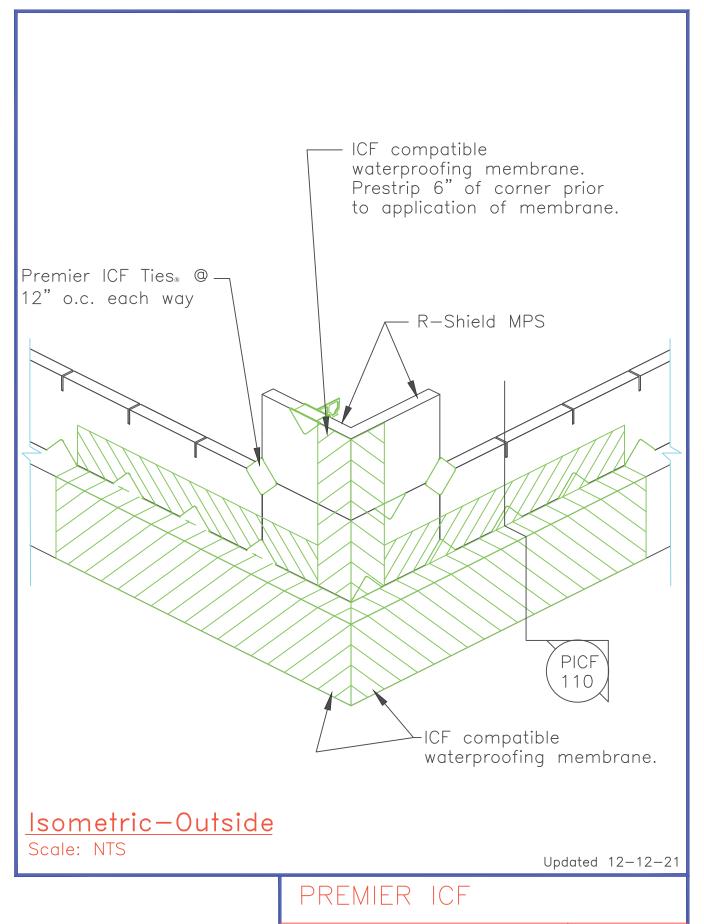


TITLE: ICF Sheet
Waterproofing at Corner

NO. PICF-111

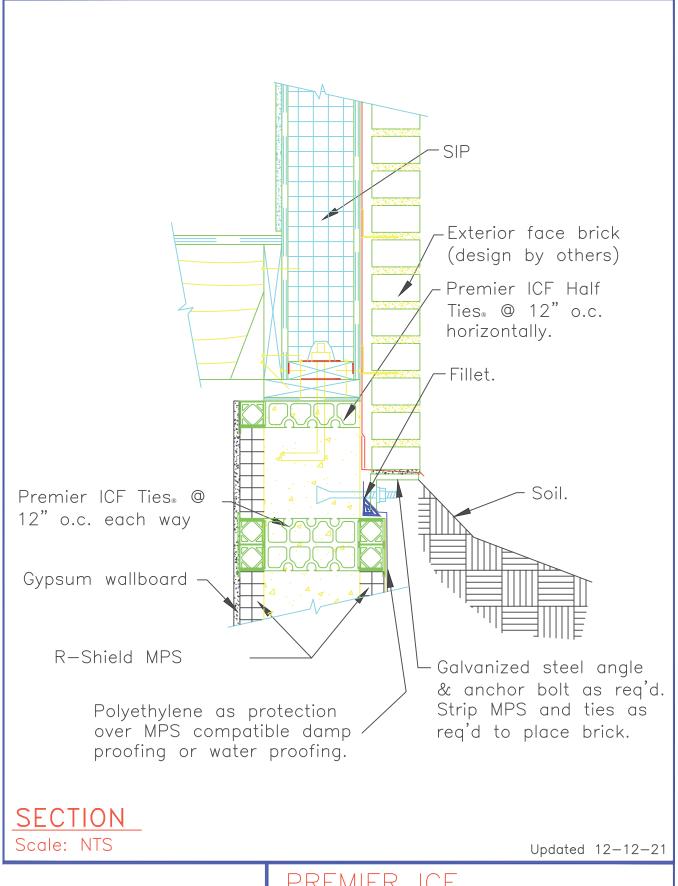

PREMIER ICF


TITLE: ICF Sheet NO. Waterproofing at Brick Angle PICF-112

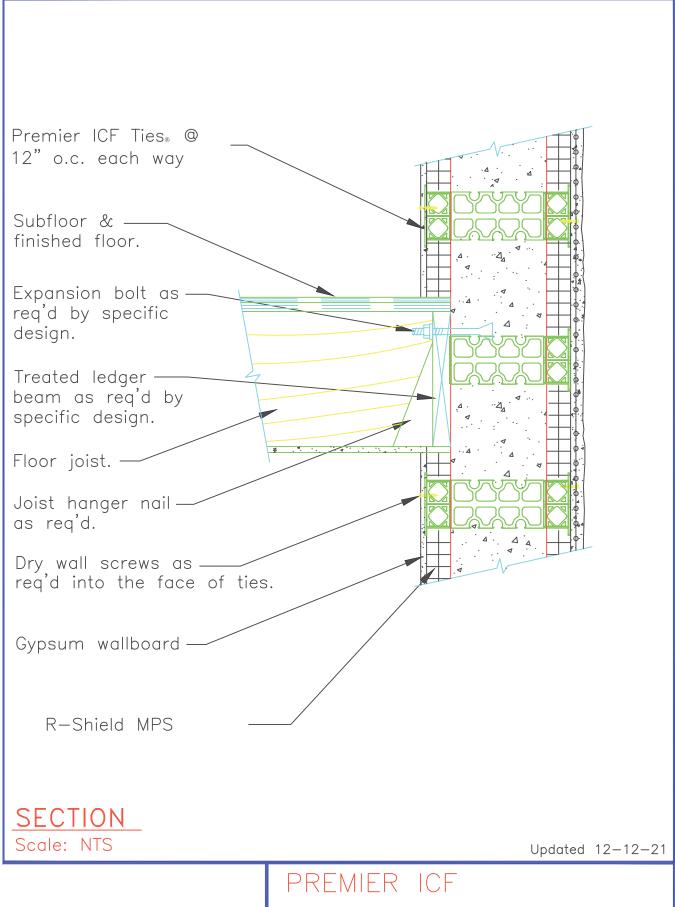

PREMIER ICF

TITLE: NO.


Ledger Supported Floor PICF-113

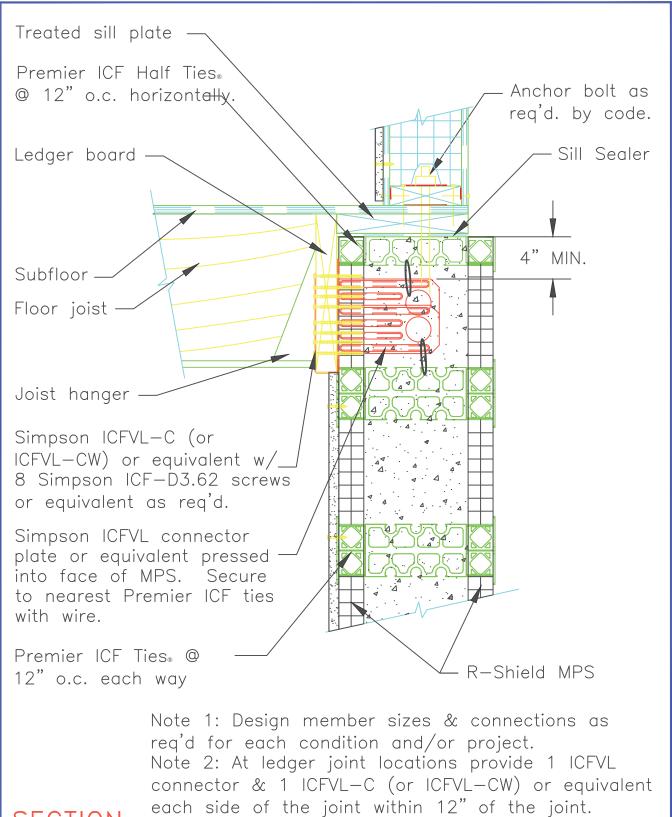

## SECTION

Scale: NTS Updated 12-12-21


## PREMIER ICF TITLE: NO. PICF-113a

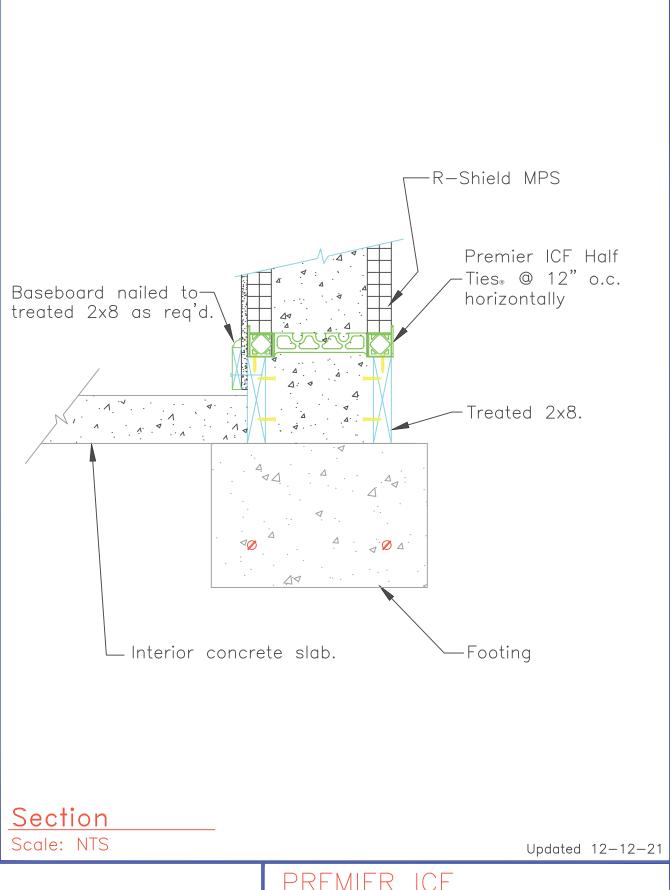

PREMIER ICF

TITLE:

Baseboard Attachment PICF-114

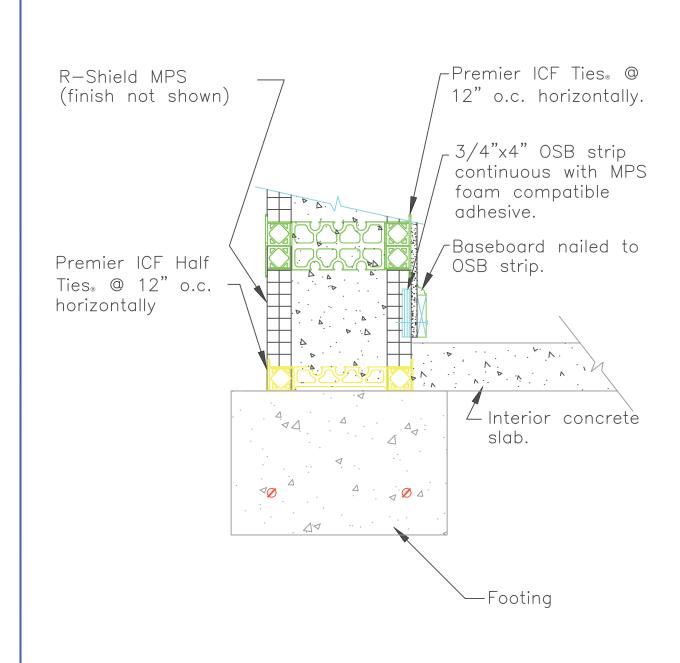

Section

Scale: NTS Updated 12-12-21

PREMIER ICF

TITLE:

Baseboard Attachment

NO.

PICF-115

